

Dan Johnson Director

DEPARTMENT OF TRANSPORTATION AND DEVELOPMENT

Development Services Building 150 Beavercreek Road Oregon City, OR 97045

BCC Agenda Date/Item:

July 24, 2025

Board of County Commissioners Clackamas County

Approval of an Amendment to a Contract with Eagle-Elsner for the South Ivy Street Pedestrian Intersection Improvements Project. Amendment Value is \$441,131.38 for 15 days. Total Contract Value is \$4,099,131.38 for 18 months. Funding is through the Oregon Department of Transportation, City of Canby and County Road Fund. No County General Funds are involved.

Previous Board	05/16/24: Approval of a Public Improvement Contract with Eagle-Elsner
Action/Review	Inc. for the South Ivy Street Pedestrian Intersection Improvements
	Project.
	12/07/23: Approval of Amendment #1 to the Intergovernmental
	Agreement between Clackamas County and the City of Canby related
	to the South Ivy Street Sidewalk Improvement Project.
	09/07/23: Approval of Amendment #3 with Kittelson & Associates, Inc.
	for the South Ivy Street Pedestrian Intersection Improvements.
	11/04/21: Approval of Amendment #2 with Kittelson & Associates, Inc.
	for the Design Services for South Ivy Street Pedestrian Intersection
	Improvements.
	9/26/19: Approval of a Contract with Kittelson & Associates, Inc. for
	Design Services for South Ivy Street Pedestrian Intersection
	Improvements.
	01/24/19: Approval of Supplemental Project Agreement 32756 with
	Oregon Department of Transportation for the S. Ivy Street (Canby)
	Project.
	01/24/19: Approval of an Intergovernmental Agreement with the City of
	Canby Related to the South Ivy Street Sidewalk Improvement Project.
	07/13/17: Approval of Supplemental Project Agreement 31172 with
	Oregon Department of Transportation for the South Ivy Street Project in
	Canby.

For Filing Use Only

Performance	The project will build a strong infrastructure and ensure safe, healthy					
Clackamas	and secure communities.	and secure communities.				
Counsel Review	Yes	Procurement Review	Yes			
Contact Person	Jordan Cools	Contact Phone	503-742-4654			

EXECUTIVE SUMMARY: The City of Canby obtained State Funded Local Projects (SFLP) funds through an Intergovernmental Agreement (IGA) with the Oregon Department of Transportation to provide bicycle lanes and sidewalk improvements on Ivy Street. The project will provide enhanced bicycle and pedestrian connectivity and include constructing bike lanes and sidewalks on both sides of the road, ADA Curb Ramp improvements, and installing a signal at the intersection of South Ivy Street and Township Road. The total length of project is approximately ³/₄ of a mile and Ivy Street will be transferred to the City upon project completion.

Eagle-Elsner Inc. was contracted to perform the construction of the project for an original contract value of \$3,658,000.00. The City has requested additional work be completed as part of the project to repair and replace poor pavement and sidewalk conditions to the south of the project limits and at side street intersections where pavement cracking and rutting are severe. Contract Amendment #1 has a not to exceed value of \$441,131.38 and includes construction of pavement repair; replacement of curb, gutter, and sidewalk; and associated traffic control and sediment and erosion control measures for the additional work.

Funding for this contract is from the SFLP Program (\$1,751,053), City of Canby (\$1,941,160.38), and County Road Fund (\$406,918). No County funds are required for Amendment #1 as the cost of the added work as requested by the City will be the City's responsibility in accordance with the IGA. The project completion date will be extended by 15 calendar days, requiring construction to be substantially completed by November 15, 2025. The contract end date of December 31, 2026 will not change and is needed for plant establishment.

PROCUREMENT PROCESS: This Amendment is in accordance with LCRB C-049-0910(2) in order to add components or phases of work specified or reasonably related to the scope of the original construction contract. The result of this Amendment #1 is a 12.1 percent increase to the original construction contract.

RECOMMENDATION: Staff recommend that the Board of County Commissioners approve and sign Amendment #1 to the Contract with Eagle-Elsner Inc. for the S. Ivy Street Improvements Project.

Respectfully submitted,

Dan Johnson

Dan Johnson, Director Department of Transportation & Development

AMENDMENT #1 TO THE CONTRACT DOCUMENTS WITH EAGLE-ELSNER INC., FOR BID# 2024-12 S. IVY STREET PEDESTRIAN INTERSECTION IMPROVEMENTS PROJECT Contract #9478

This Amendment #1 is entered into between Eagle-Elsner Inc. ("Contractor") and Clackamas County ("Owner") and shall become part of the Contract documents entered into between both parties on May 16, 2024 ("Contract").

The Purpose of this Amendment #1 is to make the following changes to the Contract:

- Section 1. Contract Price, Contract Documents and Work is hereby amended as follows: 1.
 - a. Owner authorizes an increase to the Work for quantity increases for cold plane pavement removal; hot mix asphalt concrete pavement; replacement of curb and gutter, and sidewalk; replacement of detection loops; pavement spot repairs; and associated traffic control and erosion and sediment control. The additional Work is described in Change Order #001, attached hereto as Exhibit "A" to this Amendment #1 and hereby incorporated by reference. Work will be performed in accordance with the terms and conditions of the Contract,
 - b. The Owner authorizes additional compensation in the amount of \$441,131.38 for the additional Work described in Exhibit "A" to this Amendment #1. Consideration is in accordance with the terms and conditions of the Contract. The maximum compensation authorized under this Contract shall not exceed Four Million Ninety-Nine Thousand One-Hundred Thirty-One Dollars and Thirty-Eight Cents (\$4,099,131.38).

ORIGINAL CONTRACT	\$ 3,658,000.00
AMENDMENT #1	<u>\$ 441,131.38</u>
TOTAL AMENDED CONTRACT	\$ 4,099,131.38

Except as expressly amended above, all other terms and conditions of the Contract shall remain in full force and effect. By signature below, the parties agree to this Amendment #1, effective upon the date of the last signature below.

Eagle-Elsner Inc.

Clackamas County

Authorized Signature Date Richard Eagle, President Printed Name

Date

Approved as to Form

County Counsel

7/14/2025 Date

Exhibit A Change Order #001

CONTRACT CHANGE ORDER ("CCO" or "Order") (Page 1)

PROJECT NAME (SECTION)	· · · · · ·	HIGHWAY	CONTRACT NO.
S Ivy Street Pedestrian Intersect	ion Improvements Project	S Ivy Street	9478
CONTRACTOR REPRESENTATIVE	NON-AGENCY REPRESENTATIVE	AGENCY REPRESENTATIVE	CCO NO.
Dick Eagle Dave Elsner Brent Williams		Jordan Cools	001
CONTRACTOR ADDRESS	NON-AGENCY REPRESENTATIVE ADDRESS	AGENCY REPRESENTATIVE ADDRESS	FA PROJECT NO.
Eagle-Elsner, Inc.		150 Beavercreek Rd	N/A
P.O. Box 23294		Oregon City, OR 970450	KEY NO.
Tigard, OR 97281			N/A
CONTRACTOR PHONE #	NON-AGENCY REPRESENTATIVE PHONE #	AGENCY REPRESENTATIVE PHONE #	REGION
503-628-1137		503-742-4654	N/A
CONTRACTOR EMAIL ADDRESS	NON-AGENCY REPRESENTATIVE EMAIL	AGENCY REPRESENTATIVE EMAIL ADDRESS	EA (CON NO.)
brent@eagle-elsner.com	ADDRESS	jcools@clackamas.us	N/A
	NUMERY THE CONTRACTION AND LOCATION OF WO	DK CONERED BY THIS ORDER)	

THIS CONTRACT IS HEREBY MODIFIED AS FOLLOWS BY THIS CCO (DESCRIPTION AND LOCATION OF WORK COVERED BY THIS ORDER):

This change order is in response to the City of Canby's request for added work to be completed in similar scope to the original project. This change includes quantity increases for cold plane pavement removal, hot mix asphalt concrete pavement, and replacement of curb & gutter and sidewalk, as well as adjustment of structures, replacement of detection loops in the roadway, pavement spot repairs and associated traffic control and erosion and sediment control for the additional work. The extra work is needed to repair and replace poor pavement and sidewalk conditions in the primary travel facilities and at side street intersections where pavement cracking and rutting are worst. In addition, 15 contract days will be added to the contract in Section 00180.50(h)(1).

On Page 3 of this change order is a listing of 4 new bid items and 23 adjustments of bid items from the contract's Schedule of Items, including original quantities and prices followed by the revised quantities and total bid item cost. Specifications for administering and payment of these revised bid items will be under the original contract special provisions and/or as found in the Oregon Standard Specifications for Construction 2024.

SPECIFICATIONS AND PROVISIONS - THE WORK TO BE DONE UNDER THIS CCO IS TO BE PERFORMED, MEASURED, AND PAID FOR IN ACCORDANCE WITH THE TERMS FOR THE ABOVE CONTRACT EXCEPT AS MODIFIED AS FOLLOWS:

Add new pay items as follows:

4001 Detector Installation, Traffic Loops	5 EA	
4002 Detector Installation, Bicycle Loop	1 EA	
4003 Cold Plane Pavement Removal, 3 Inches Deep	3400 SY	
4004 Extra For Spot Grind Repairs		3400

Make the following changes to pay items in the existing Schedule of Items with unit pricing to remain unchanged:

04 Temporary Work Zone Traffic Control, Complete (LS) increased by \$57,250.00 for a new total of 1.0 LS (\$289,920.35)

07 Erosion Control (LS) increased by \$3,350.00 for a new total of 1.0 LS (\$25,350.00)

08 Sediment Fence increased by 1350 LF (\$5,872.50) for a new total of 5,694.00 LF (\$24,768.90)

09 Inlet protection, Type 3 increased by 3 EA (\$270.00) for a new total of 55 EA (\$4,950.00)

13 Construction Survey Work (LS) increased by \$15,050.00 for a new total of 1.0 LS (\$75,050.00)

18 Clearing and Grubbing (LS) increased by 12,350.00 for a new total of 1.0 LS (62,350.00)

19 General Excavation increased by 400 CY (\$14,400.00) for a new total of 3,484.00 CY (\$125,424.00)

22 Subgrade Geotextile increased by 600 SY (\$900.00) for a new total of 4,703.00 SY (\$7,054.50)

34 Adjusting Boxes increased by 5 EA (\$875.00) for a new total of 75 EA (\$13,125.00)

38 Cold Plane Pavement Removal, 0 - 2 1/2 Inches Deep increased by 5500 LF (\$15,675.00) for a new total of 19,215.00 LF (\$54,762.75)

SY

39 Aggregate Base increased by 500 TON (\$21,500.00) for a new total of 4,573.00 TON (\$196,639.00)

40 Level 3, 1/2" ACP Mixture increased by 1350 TON (\$132,300.00) for a new total of 4,173.00 TON (\$408,954.00)

41 Extra for Asphalt Approaches increased by 2000 SF (\$4,500.00) for a new total of 9,302.00 SF (\$20,929.50)

43 Concrete Curbs - Standard Curb & Gutter increased by 1350 LF (\$33,750.00) for a new total of 6,983.00 LF (\$174,575.00)

47 Concrete Walks increased by 7500 LF (\$75,000.00) for a new total of 29,775.00 LF (\$297,750.00)

(Cont. on Page 2)

CONTRACTOR SIGNATURE MAKES THIS CCO A SUPPLEMENTAL AGREEMENT AND IS: Required

FOR SUPPLEMENTAL AGREEMENTS ONLY: Contractor: Confirm your agreement by signing, dating and returning the original to the Resident Engineer. Work shall not begin until you are notified that the agreement has either been approved or that work may commence under advance approval. Your signature further confirms agreement that payments in accordance with the agreement constitute full and complete compensation for all costs, both direct and indirect, arising out of the described work covered by this agreement, and releases and discharges the State from other costs except as provided herein.

AGREED TO BY CONTRACTOR	DATE	AGENCY REPRESENTATIVE	DATE
Print		Print	
Sign		Sign	
RECOMMENDED BY LOCAL AGENCY	DATE	AGENCY MANAGER	DATE
Print		Print	
Sign		Sign	
RECOMMENDED BY NON-AGENCY REPRESENTATIVE	DATE	CONSTRUCTION	DATE
Print		Print	
Sign		Sign	

CONTRACT CHANGE ORDER ("CCO" or "Order") (Page 2)

PROJECT NAME (SECTION)		HIGHWAY	CONTRACT NO.
S Ivy Street Pedestrian Intersect	ion Improvements Project	S Ivy Street	9478
CONTRACTOR REPRESENTATIVE	NON-AGENCY REPRESENTATIVE	AGENCY REPRESENTATIVE	CCO NO.
Dick Eagle Dave Elsner Brent Williams		Jordan Cools	001
CONTRACTOR ADDRESS	NON-AGENCY REPRESENTATIVE ADDRESS	AGENCY REPRESENTATIVE ADDRESS	FA PROJECT NO.
Eagle-Elsner, Inc.		150 Beavercreek Rd	N/A
P.O. Box 23294		Oregon City, OR 970450	KEY NO.
Tigard, OR 97281			N/A
CONTRACTOR PHONE #	NON-AGENCY REPRESENTATIVE PHONE #	AGENCY REPRESENTATIVE PHONE #	REGION
503-628-1137		503-742-4654	N/A
CONTRACTOR EMAIL ADDRESS	NON-AGENCY REPRESENTATIVE EMAIL	AGENCY REPRESENTATIVE EMAIL ADDRESS	EA (CON NO.)
brent@eagle-elsner.com	ADDRESS	jcools@clackamas.us	N/A

THIS CONTRACT IS HEREBY MODIFIED AS FOLLOWS BY THIS CCO (DESCRIPTION AND LOCATION OF WORK COVERED BY THIS ORDER):

See previous page.

SPECIFICATIONS AND PROVISIONS - THE WORK TO BE DONE UNDER THIS CCO IS TO BE PERFORMED, MEASURED, AND PAID FOR IN ACCORDANCE WITH THE TERMS FOR THE ABOVE CONTRACT EXCEPT AS MODIFIED AS FOLLOWS:

(Cont. from Page 1)

Make the following changes to pay items in the existing Schedule of Items with unit pricing to remain unchanged:

53 Bi-Directional Yellow Type I Markers increased by 25 EA (\$450.00) for a new total of 31.00 EA (\$558.00)

- 54 Thermoplastic, Extruded or Sprayed, Surface, Non-profiled increased by 3500 LF (\$4,375.00) for a new total of 23,405.00 LF (\$29,256.25)
- 55 Pavement Legend, Type AB: Arrows increased by 2 EA (\$640.00) for a new total of 24 EA (\$7,680.00)

56 Pavement Legend, Type B-HS: Bike Lane Stencil increased by 4 EA (\$1,260.00) for a new total of 26 EA (\$8,190.00)

59 Pavement Bar, Type B-HS increased by 200 SF (\$2,400.00) for a new total of 948.00 SF (\$11,376.00)

69 Permanent Seeding increased by 0.05 ACRE (\$1,050.00) for a new total of 0.20 ACRE (\$4,137.00)

70 Topsoil increased by 20 CY (\$1,900.00) for a new total of 139.00 CY (\$13,205.00)

71 Bark Mulch increased by 20 CY (\$1,800.00) for a new total of 312.00 CY (\$28,080.00)

Change Special Provisions Section 00180.50(h)-Contract Time, (1) "Complete all Work to be done under the Contract, except for seeding establishment not later than October 31, 2025." to "Complete all Work to be done under the Contract, except for seeding establishment not later than November 15, 2025."

For Item 4004, spot grind repairs shall be performed at the direction of the Engineer after initial cold plane pavement removal. Payment under 4003 shall be in addition to payment for cold plane pavement removal under Item 4003 and hot mix asphalt concrete paving under Bid Item 40.



CONTRACT CHANGE ORDER (Page 3)


	AME (SEC		CONTRACT NO		CONTINUATION	
Ivy Stre	et Pede	estrian Intersection Improvements Project	9478			001
		REVISED BID ITEN	IS			
		Description	Est. Qty.	Unit	Unit Price	Amount
4	00221	Temporary Work Zone Traffic Control, Complete	1.00	LS	\$ 232,670.35	\$ 232,670.3
		Revised				
4	00221	Temporary Work Zone Traffic Control, Complete	1.00	LS	\$ 289,920.35	\$ 289,920.3
7	00280	Erosion Control	1.00	LS	\$ 22,000.00	\$ 22,000.0
		Revised				
		Erosion Control	1.00	_	\$ 25,350.00	\$ 25,350.0
8	00280	Sediment Fence	4,344.00	LE	\$ 4.35	\$ 18,896. ⁄
		Revised				
8	00280	Sediment Fence	5,694.00		\$ 4.35	\$ 24,768.9
9	00280	Inlet protection, Type 3-	52.00	EA	\$ 90.00	\$ 4,680.0
		Revised				
9	00280	Inlet protection, Type 3	55.00	EA	\$ 90.00	\$ 4,950.0
13	00305	Construction Survey Work	1.00	LS	\$ 60,000.00	\$ 60,000.0
		Revised				
13	00305	Construction Survey Work	1.00	LS	\$ 75,050.00	
18	00320	Clearing and Grubbing-	1.00	LS	\$ 50,000.00	\$ 50,000.(
		Revised				
18	00320	Clearing and Grubbing	1.00	LS	\$ 62,350.00	\$ 62,350.0
19	00330	General Excavation	3,084.00	CY	\$ 36.00	\$ 111,024.
		Revised				
19	00330	General Excavation	3,484.00	CY	\$ 36.00	\$ 125,424.0
22	00350	Subgrade Geotextile	4,103.00	SY	\$ 1.50	\$ 6,154.
		Revised				
22	00350	Subgrade Geotextile	4,703.00	SY	\$ 1.50	\$ 7,054.
34	00490	Adjusting Boxes	70.00	EA	\$ 175.00	\$ 12,250.0
		Revised				
34	00490	Adjusting Boxes	75.00	EA	\$ 175.00	\$ 13,125.0
38	00620	Cold Plane Pavement Removal, 0 - 2 1/2 Inches Deep	13,715.00	S¥	\$ <u>-2.85</u>	\$ 39,087.
		Revised				
38	00620	Cold Plane Pavement Removal, 0 - 2 1/2 Inches Deep	19,215.00	SY	\$ 2.85	\$ 54,762.
		Aggregate Base	4,073.00		\$ 43.00	
		Revised	.,		¢ .0.00	¢e,ee.
39	00641	Aggregate Base	4,573.00	TON	\$ 43.00	\$ 196,639.0
		Level 3, 1/2" ACP Mixture	2,823.00		\$ 98.00	
	00111	Revised	2,020.00	1011	φ 00.00	φ 210,004.
40	00744	Level 3, 1/2" ACP Mixture	4,173.00	TON	\$ 98.00	\$ 408,954.0
		Extra for Asphalt Approaches	7,302.00	_		\$ 16,429.
	00745		7,002.00	9-	φ <u>2.20</u>	\$ 10,420.
/1	00740	Revised Extra for Asphalt Approaches	9,302.00	SE	\$ 2.25	\$ 20,929.
	-		<u>5,633.00</u>	-		
43	00759	Concrete Curbs Standard Curb & Gutter	5,633.00	╘╞╴	\$ 25.00	\$ 140,825. (
40	00750	Revised	6,983.00		¢ 05.00	¢ 474 575 (
		Concrete Curbs - Standard Curb & Gutter	-	-	\$ 25.00	\$ 174,575.
47	00759	Concrete Walks	22,275.00	-S⊨	\$ 10.00	<u>\$ 222,750.0</u>
4-	00750	Revised	00 775 00	05	¢ 40.00	¢ 007 750 f
47	-	Concrete Walks	29,775.00		\$ 10.00	\$ 297,750.0
53	00865	Bi-Directional Yellow Type Markers	6.00	EA	\$	\$ 108.0
		Revised				
		Bi-Directional Yellow Type I Markers	31.00		\$ 18.00	\$ 558.0
5 4	00867	Thermoplastic, Extruded or Sprayed, Surface, Non-profiled	- 19,905.00	LF	\$ 1.25	\$ 24,881.2
		Revised				
54	00867	Thermoplastic, Extruded or Sprayed, Surface, Non-profiled	23,405.00	LF	\$ 1.25	\$ 29,256.2

(Cont. on Pg. 4)



CONTRACT CHANGE ORDER (Page 4)

vy Street F		ION)	CONTRACT NO.		С	ONTINUATION	OF C	CO NO.:
	Pede	strian Intersection Improvements Project	9478				00)1
(Cont. fro	rom Pa	REVISED BID ITEMS (0						
EE 000	0007	Pavement Legend, Type AB: Arrows-	<u>22.00</u>		¢	320.00	¢	7.040.0
-99 -000			22.00	EA	\$	320.00	\$	7,040.0
55 009		<u>ævised</u> Pavement Legend, Type AB: Arrows	24.00		\$	320.00	\$	7,680.0
		Pavement Legend, Type A.B. Arrows Pavement Legend, Type B HS: Bike Lane Stencil	24.00		\$ \$	315.00	. · ·	
			22.00	EA	\$	310.00	ò	0,930.0
56 002		<u>Revised</u> Pavement Legend, Type B-HS: Bike Lane Stencil	26.00	FΔ	\$	315.00	\$	8,190.0
	_	Pavement Bar, Type B-HS-	748.00	-	Ψ \$	12.00	-	8,976.0
		Revised	740.00	0 -	φ	12.00	φ	0,070.0
59 008		Pavement Bar, Type B-HS	948.00	SE	\$	12.00	\$	11,376.0
	-	Permanent Seeding		ACRE		21.000.00		3.087.0
		Revised	0.10	FORE	Ψ	21,000.00	Ψ	0,001.0
69 010		Permanent Seeding	0.20	ACRE	\$	21,000.00	\$	4,137.0
70 010	_		119.00		\$	95.00	. · ·	11,305.0
		Revised		•.	Ŧ	00.00	Ŧ	,
70 010			139.00	CY	\$	95.00	\$	13,205.0
	_	Bark Mulch	292.00		\$	90.00	<u> </u>	26,280.0
		Revised		• .	Ŧ	00.00	Ŧ	20,200
71 010		Bark Mulch	312.00	CY	\$	90.00	\$	28,080.0
		ADDED BID ITEM						,
y Item Spe	ec [Description		Unit	Uni	it Price	Δm	ount
		Detector Installation, Traffic Loops	5.00	_	\$	1,799.73	_	8,998.0
		Detector Installation, Bicycle Loop	1.00	-	\$	1,959.23		1,959.2
		Cold Plane Pavement Removal, 3 Inches Deep	3,400.00		\$	3.42		11,628.0
1000 001					\$	3.42		11,628.0
4004 007)749 E	Extra For Spot Grind Repairs	3,400.00	SY	Φ	0.12	\$	
4004 001	<u>1749 F</u>	Extra For Spot Grind Repairs	3,400.00	SY	Φ	0.12	\$	

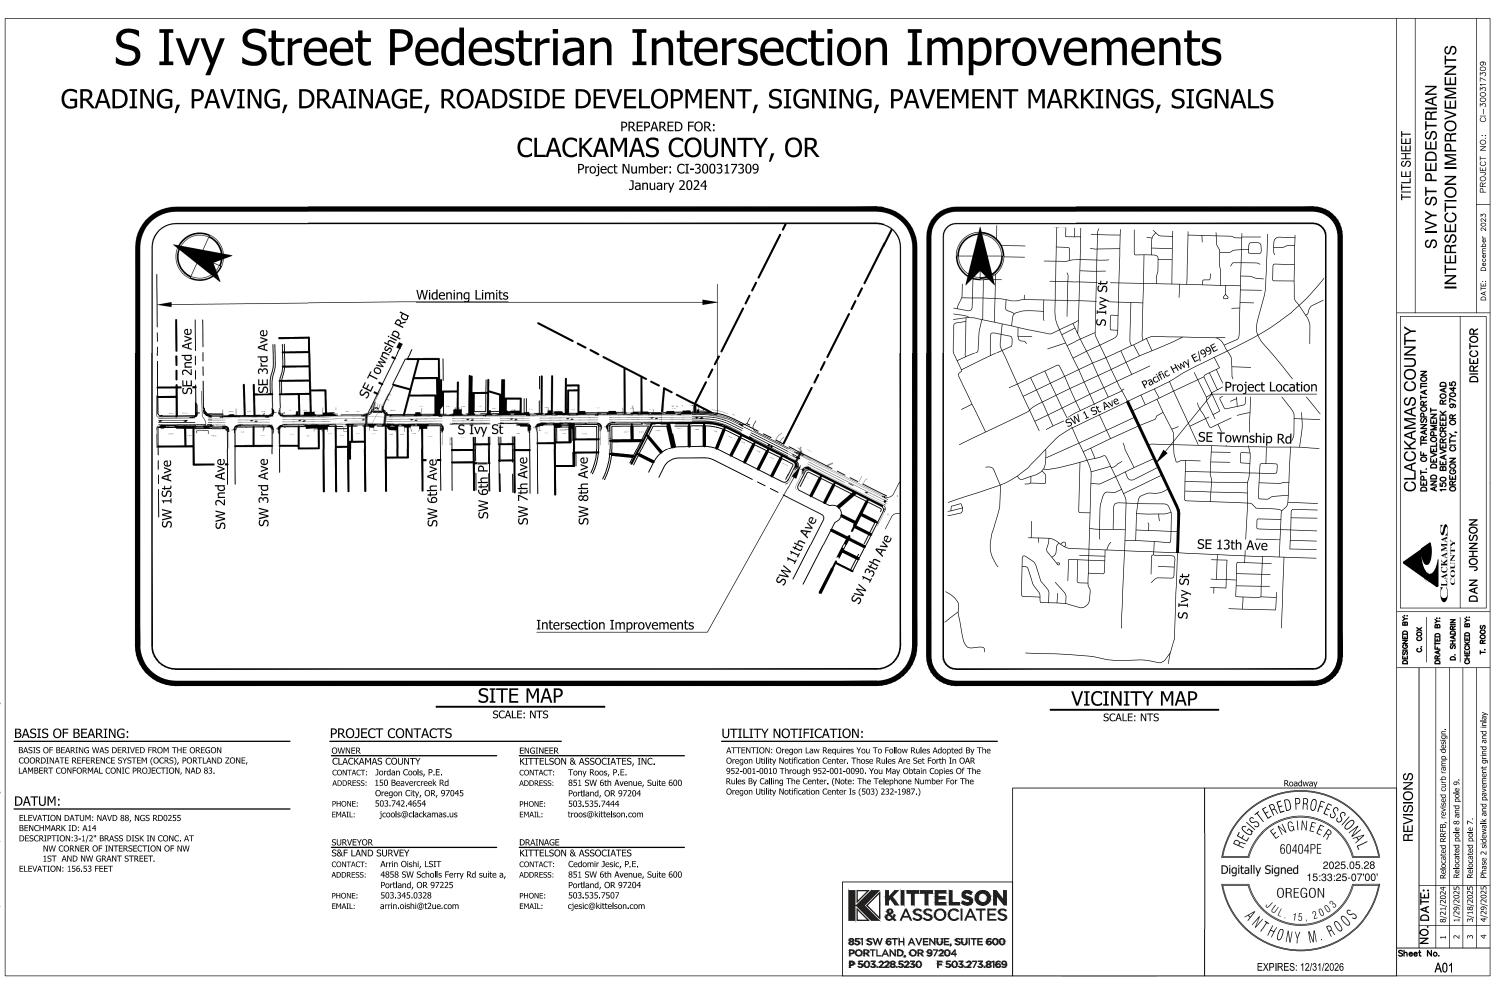

lot lot

IATIONS							
					(Sheet Number	Sheet
Delta Angle	MJ	Mechanical Joint	W	Water	(BA00.1	Typical
Asphalt Concrete	NO.	Number	-	- /	7	BE00.1	Intersec
Asphalt Concrete Pavement	NOM.	Nominal	WQMH	Water Quality Manhole	· · · · · · · · · · · · · · · · · · ·		
Area Drain	N.T.S./NTS	Not to Scale			<u>}</u>		General
American Disabilities Act	ODOT	Oregon Department of Transportation			5	FB02.1	Grading
Bottom of Curb	OSSC	Oregon Standard Specifications for Construction			(LA00.1	Sign Ins
Begin Vertical Curve	PC	Point of Curvature			(MD01 Thru MD03	Detecto
Back of Sidewalk	PCC	Point of Compound Curvature			`		-
Catch Basin	PE	Plain End			>	QA01.1	Paveme
Curb Inlet	CUB	Canby Utility Board			5		
Composite	PI	Point of Inflection			(
Ductile Iron	PSUE	Public Slope & Utility Easement			(
Drawing	PRC	Point of Reverse Curvature			7		
Electrical	PSDUE	Public Slope, Drainage, & Utility Easement			> >		
Each	PSE	Public Slope Easement			2		
Edge of Asphalt Concrete	PT	Point of Tangency					
Elevation	PUE	Public Utility Easement			<u> </u>	h	\sim
End Vertical Curve	PVC	Poly Vinyl Chloride					
Existing	PVI	Point of Vertical Inflection					
Flow Line	R	Radius					
Flange	RCP	Reinforced Concrete Pipe					
Feet	R/W	Right-of-Way					
	Rt.	Right					
-	S	Slope					
Gas Valve	Sta.	Station					
	SD	Storm Drain					
	Sht.	Sheet					
•	Т	Telecom					
	TC	Top of Curb at Face					
	THKN.	Thickness					
5	TRK	Truck					
Manhole	VC	Vertical Curve					
Minimum							
	Asphalt Concrete Asphalt Concrete Pavement Area Drain American Disabilities Act Bottom of Curb Begin Vertical Curve Back of Sidewalk Catch Basin Curb Inlet Composite Ductile Iron Drawing Electrical Each Edge of Asphalt Concrete Elevation End Vertical Curve Existing Flow Line Flange Feet Flat Top Gas Gas Valve Invert Elevation Length Linear Feet Left Length of Vertical Curve Maximum Manhole	Asphalt ConcreteNO.Asphalt Concrete PavementNOM.Area DrainN.T.S./NTSAmerican Disabilities ActODOTBottom of CurbOSSCBegin Vertical CurvePCBack of SidewalkPCCCatch BasinPECurb InletCUBCompositePIDuctile IronPSUEDrawingPRCElectricalPSDUEEachPSEEdge of Asphalt ConcretePTElevationPUEEnd Vertical CurvePVCExistingPVIFlow LineRFlangeRCPFeetR/WFlat TopRt.GasSGas ValveSta.Invert ElevationSDLengthSht.Linear FeetTLeftTCLength of Vertical CurveTHKN.MaximumTRKManholeVC	Asphalt ConcreteNO.NumberAsphalt Concrete PavementNOM.NominalArea DrainN.T.S./NTSNot to ScaleAmerican Disabilities ActODOTOregon Department of TransportationBottom of CurbOSSCOregon Standard Specifications for ConstructionBegin Vertical CurvePCPoint of CurvatureBack of SidewalkPCCPoint of Compound CurvatureCatch BasinPEPlain EndCurb InletCUBCanby Utility BoardCompositePIPoint of InflectionDuctile IronPSUEPublic Slope & Utility EasementDrawingPRCPoint of Reverse CurvatureElectricalPSDUEPublic Slope, Drainage, & Utility EasementEachPSEPublic Slope EasementEdge of Asphalt ConcretePTPoint of Vertical InflectionPUEPublic Slope ConcretePUPiont of Vertical InflectionPUEFlangeRCPReinforced Concrete PipeFeetR/WRight-of-WayFlangeSaSlopeGas SSlopeStar.Gas ValveSta.StationInvert ElevationSDStorm DrainLengthSht.SheetLinear FeetTTelecomLength of Vertical CurveTHKN.ThicknessMaximumTRKTruckMaximumKKVertical Curve	Asphalt ConcreteNO.NumberWQAsphalt Concrete PavementNO.NumberWQAsphalt Concrete PavementNOM.NominalWQMHArea DrainN.T.S./NTSNot to ScaleWQMHAmerican Disabilities ActODOTOregon Department of TransportationImage: ConstructionBedin of CurbOSSCOregon Standard Specifications for ConstructionImage: ConstructionBegin Vertical CurvePCPoint of CurvatureImage: ConstructionBack of SidewalkPCCPoint of Compound CurvatureImage: ConstructionCatch BasinPEPlain EndImage: ConstructionCurb InletCUBCanby Utility BoardImage: ConstructionCompositePIPoint of InflectionImage: ConstructionDuctile IronPSUEPublic Slope & Utility EasementImage: ConstructionDrawingPRCPoint of Reverse CurvatureImage: ConstructionElectricalPSDUEPublic Slope, Drainage, & Utility EasementImage: ConstructionEachPSEPublic Slope EasementImage: ConstructionImage: ConstructionEdge of Asphalt ConcretePTPoint of TangencyImage: ConstructionElectricalPVCPoly Viny UhorideImage: Construct Poly ConstructionEnd Vertical CurvePVCPoly Ving UhorideImage: Construct PolyEvatingPV1Point of Vertical InflectionImage: Construct PolyFlat TopRt.Right-of-WayImage: Construct Poly	Asphalt ConcreteNGNumberWQWater QualityAsphalt Concrete PavementNOM.NominalWQMHWater Quality ManholeArea DrainN.T.S./NTSNot to ScaleAmerican Disabilities ALODOTOregon Department of TransportationBottom of CurbOSSCOregon Standard Specifications for ConstructionBegin Vertical CurvePCPoint of CurvatureBack of SidewalkPCCPoint of Compound CurvatureCath BasinPEPlain EndCurb InletCUBCaby Utility BasendCompositePIPoint of InflectionDuctile IronPSUEPublic Slope & Utility EasementDrawingPRCPoint of InflectionDuctile IronPSUEPublic Slope, Drainage, & Utility EasementElectricalPSDUEPublic Slope, Drainage, & Utility EasementEdge of Asphalt ConcretePTPoint of TangencyElevationPUEPublic Utility EasementEdge of Asphalt ConcretePTPoint of TangencyElevationPUEPublic Utility EasementFord Vertical CurvePVCPoly Vinyl ChlorideEvastingPVIPoint of Vertical InflectionFlow LineRRadiusFlangeRCPReinforced Concrete PipeFeetRWRight-GavaGas ValveSataStationInvert ElevationSDStorm DrainLinear FeetTTelecomLinear FeetTCSpo Curvet af FaceLi	Asphat Concrete NO, Number WQ Water Quality Asphat Concrete Pavement NOI. Nominal WQMH Water Quality Manhole Area Drain N.T.S./NT Not to Scale Immerican Disabilities Act. ODOT Oregon Department of Transportation Bottom of Curb OSS Oregon Department of Transportation Bedities Act. ODOT Oregon Department of Transportation Bottom of Curb OSS Oregon Standard Specifications for Construction Edities Act. Odot of Curvature Back of Sidewalk PCC Point of Inflection Point of Inflection Optint of Reverse Curvature Edities Act. Edities Act. Ductile Iron PSUE Public Slope Easement Edities Act. Edities Act. Edities Act. Edit Oncrete PT Point of Traffection Point of Traffection Edities Act. Edities Act. Edities Act. Electrical PSDUE Public Slope Easement Edities Act. E	Asphalt Concrete Payement NO. Number WQ Water Quality Asphalt Concrete Payement NOH. Nominal WQMH Water Quality Manhole Area Drain N.T.S./NTS ODOT Oregon Department of Transportation Immediate Concrete Payement Immediate Concrete Payement PC American Disabilities Act ODOT Oregon Standard Specifications for Construction Immediate Payement PR02.1 Bedin Vertical Curve PC Point of Curvature Immediate Payement Proving Back of Stiewalk PC Point of Curvature Immediate Payement Proving Catch Basin PE Plain End Immediate Payement Point of Infection Out of Unit Spece Curvature PL Public Spece Curvature Immediate Payement Doraving PRC Public Spece Curvature Immediate Payement Deraving PSE Public Spece Curvature Immediate Payement Edextorial Curve PVC Public Spece Curvature Immediate Payement Edextorial Curve PVC Public Spece Curvature Immediate Payement Edextorial Curve PVC Public Spece Survature Immediate Payement Edextorial Curve PVC Public Spece Survature Immediate Payemediate Payement </td

\sim	<u>~~~~~</u>	\sim		
ion #	4 Index of Sheets			
nber	Sheet Title		Sheet Number	Sheet
	Typical Sections		A01	Title She
L	Intersection Grading Details	5	A02	Title She
& C01.1	General Construction	5	A03	Plan She
	Grading and Erosion Control	5	A04	Survey 0
	Sign Installation Plan	5	BA01 Thru BA05	Typical
MD03	Detector Plan	5	BB01 Thru BB04	Details
L	Pavement Marking Plans	5	BC01Thru BC30	Curb Ra
		5	BD01 Thru BD06	Drive W
)	BE01Thru BE08	Intersec
			C01Thru C10	General
			EA01Thru EB01	Traffic C
)	EB02Thru EB09	Traffic C
\sim				

 $\sim\sim\sim\sim$

Revision #4


		Index of Sl				6	
Sheet Number	Sheet Title	Sheet Number	Sheet Title			Ĕ	0
A01	Title Sheet	EB10 Thru EB17	Traffic Control Plan - Phase III				730
A02	Title Sheet	FB01Thru FB08	Grading and Erosion Control			ZB	031
A03	Plan Sheet Layout	LA01 Thru LA04	Sign Installation Plan			₹ū	CI-300317309
A04	Survey Control Data	LB01 Thru LB05	Sign Detai l s			ЩN	능
BA01 Thru BA05	Typical Sections	MA01	Signal Legend		ьI	ы М	
BB01 Thru BB04	Details	MB01-A Thru MB02	Signal Plan		TITLE SHEET	뜨 뜨	NO.:
BC01Thru BC30	Curb Ramp Details	MC01 Thru MC05	Signal Details		우	Ξ	PROJECT
BD01 Thru BD06	Drive Way Grading Details	QA01 Thru QA05	Pavement Marking Plans		Ш		GUE
BE01Thru BE08	Intersection Grading Details	QB01Thru QB03	Pavement Marking Details		E	ΗŌ	L L
C01Thru C10	General Construction					S Ē	
EA01Thru EB01	Traffic Control Plan - Details					×Ω	2023
EB02Thru EB09	Traffic Control Plan - Phase II					S IVY ST PEDESTRIAN ERSECTION IMPROVEMENTS	
UTILITY C	ONTACTS					Ш	December
WATER/ELECTR		COMMUNICA	TIONS			E	
CANBY UTILI		DIRECT LIN				=	DATE:
CONTACT: Jas	son Berning	CONTACT:	Eric Kehler				
	65 SE 3rd Ave, nby, OR 97013		190 SE 2nd Ave Canby OR 97013	h			
	3.263.4307		503.266.8223		≻		Ж
EMAIL: JBe	erning@canbyutility.org	EMAIL: 0	eric.kehler@cbsoregon.com		Ξ		Ы
					Ē		DIRECTOR
		Sanitary Sewe			S	No on	Ξ
NW NATURAL CONTACT: Da	rrell Hammond	City of Canb CONTACT:	y Jerry Nelzen			RTATIC ROAD 97045	
	0 NW Second Ave		1470 NE Territorial Rd, PO Box 930		AS	8 × 26	
	rtland, OR 97209		Canby, OR 97013		4	<u>е</u> ддя	
	3.610.7746 rrell.hammond@nwnatural.con		503.266.0759 nelzenj@canbyoregon.gov		AM/	TRANSPORTATION OPMENT RCREEK ROAD ITY, OR 97045	
					Ж	. 님변요!	
BROADBAND						P M M M	
WAVE					Ľ	AND 150 E	
	bert Lee				O	ଅ≨ଅନ	
	9 Glatt Circle podburn, OR 97071						
	3.707.1076						~
EMAIL: rle	e@wavebroadband.com					Ŋ	<u>ö</u>
						A YA	žΙ
							NOSNHOL
Proposed Sidewa	lk						DAN
Variable Depth G	rind and 2" Inlay				 ۲	ل ت ما	
Full Depth ACP Re					Designed by:	C. COX DRAFTED BY: D. SHADRIN	checked BY: T. Roos
Bark Mulch Install					DESIG	DRAF C	CHECI
Concrete Drivewa							
ACP Driveway Rep	Dair						
						1 inlay	
						and	
						Irind	
					~	ent jo	
					S	/em/	
			-D DDO-		REVISIONS	ba	
			TEREDPROFESS		ŝ	and	
			NGINEE		б	ak	
			ENGINEER 60404PE	こ	£	sider	
			60404PE			Phase 2 sidewalk and pavement grind and	
			Digitally Signed 2025	05.28		has	
Г							- -
		SON	OREGON			DATE: 4/29/2025	
	& ASSOC	ATES	The 15, 2003 05			DATE 4/29/202	
			M/HONY M. ROS			1	\vdash
	851 SW 6TH AVENUE, S		VYONY M. M			Z ↑	
-	PORTLAND, OR 97204			5	Shee	et No.	
	P 503.228.5230 F 503	5.273.8169	EXPIRES: 12/31/2026			A02	


Sheet Number Sheet Title Sheet Number Sheet Title A01 Title Sheet EB10 Thru EB17 Traffic Control Plan - Phase III A02 Title Sheet FB01Thru FB08 Grading and Erosion Control A03 Plan Sheet Layout LA01 Thru LA04 Sign Installation Plan A04 Survey Control Data LB01 Thru LB05 Sign Details BA01 Thru BA05 Typical Sections MA01 Signal Legend BB01 Thru BB04 Details MB01-A Thru MB02 Signal Details BC01Thru BC30 Curb Ramp Details MC01 Thru C05 Signal Details BD01 Thru BD66 Drive Way Grading Details QA01 Thru QA05 Pavement Marking Plans BE01Thru B088 Intersection Grading Details QB01Thru QB03 Pavement Marking Details C01Thru C10 General Construction E01Thru QB03 Pavement Marking Details				
A02 Title Sheet FB01Thru FB08 Grading and Erosion Control A03 Plan Sheet Layout LA01 Thru LA04 Sign Installation Plan A04 Survey Control Data LB01 Thru LB05 Sign Details BA01 Thru BA05 Typical Sections MA01 Signal Legend BB01 Thru BB04 Details MB01-A Thru MB02 Signal Plan BC01Thru BC30 Curb Ramp Details MC01 Thru MC05 Signal Details BD01 Thru BD06 Drive Way Grading Details QA01 Thru QA05 Pavement Marking Plans BE01Thru BE08 Intersection Grading Details QB01Thru QB03 Pavement Marking Details	L3		IS	
A03 Plan Sheet Layout LA01 Thru LA04 Sign Installation Plan A04 Survey Control Data LB01 Thru LB05 Sign Details BA01 Thru BA05 Typical Sections MA01 Signal Legend BB01 Thru BB04 Details MB01-A Thru MB02 Signal Plan BC01Thru BC30 Curb Ramp Details MC01 Thru MC05 Signal Details BD01 Thru BD06 Drive Way Grading Details QA01 Thru QA05 Pavement Marking Plans BE01Thru BE08 Intersection Grading Details QB01Thru QB03 Pavement Marking Details			Ż	309
A04 Survey Control Data LB01 Thru LB05 Sign Details BA01 Thru BA05 Typical Sections MA01 Signal Legend BB01 Thru BA04 Details MB01-A Thru MB02 Signal Plan BC01Thru BC30 Curb Ramp Details MC01 Thru MC05 Signal Details BD01 Thru BD06 Drive Way Grading Details QA01 Thru QA05 Pavement Marking Plans BE01Thru BE08 Intersection Grading Details QB01Thru QB03 Pavement Marking Details			, 쁜	317
BA01 Thru BA05 Typical Sections MA01 Signal Legend BB01 Thru BB04 Details MB01-A Thru MB02 Signal Plan BC01Thru BC30 Curb Ramp Details MC01 Thru MC05 Signal Details BD01 Thru BD06 Drive Way Grading Details QA01 Thru QA05 Pavement Marking Plans BE01Thru BE08 Intersection Grading Details QB01Thru QB03 Pavement Marking Details		ST PEDESTRIAN	Ξ	CI-300317309
BB01 Details MB01-A Thru MB02 Signal Plan BC01Thru BC30 Curb Ramp Details MC01 Thru MC05 Signal Details BD01 Thru BD06 Drive Way Grading Details QA01 Thru QA05 Pavement Marking Plans BE01Thru BE08 Intersection Grading Details QB01Thru QB03 Pavement Marking Details			\mathbb{Z}	님
BC01Thru BC30 Curb Ramp Details MC01 Thru MC05 Signal Details BD01 Thru BD06 Drive Way Grading Details QA01 Thru QA05 Pavement Marking Plans BE01Thru BE08 Intersection Grading Details QB01Thru QB03 Pavement Marking Details	1 LU	15	5 2	.,
BD01 Thru BD06 Drive Way Grading Details QA01 Thru QA05 Pavement Marking Plans BE01Thru BE08 Intersection Grading Details QB01Thru QB03 Pavement Marking Details	1	μü	ĺЪ	NO.:
BE01Thru BE08 Intersection Grading Details QB01Thru QB03 Pavement Marking Details	SHEET		j∑	CT
	TITLE	l a	- 2	PROJECT
C01Thru C10 General Construction			Ξ	L CL
	· .	U S	, E	-
EA01Thru EB01 Traffic Control Plan - Details		∣≥		2023
EB02Thru EB09 Traffic Control Plan - Phase II			ERSECTION IMPROVEMENTS	
UTILITY CONTACTS			Ë	December
WATER/ELECTRICAL COMMUNICATIONS			Ξ	
CANBY UTILITY DIRECT LINK			=	DATE:
CONTACT: Jason Berning CONTACT: Eric Kehler				
ADDRESS: 1265 SE 3rd Ave, ADDRESS: 190 SE 2nd Ave Canby, OR 97013 Canby OR 97013				
PHONE: 503.263.4307 PHONE: 503.266.8223	2	-		R
EMAIL: JBerning@canbyutility.org EMAIL: eric.kehler@cbsoregon.com		2		CT
GAS Sanitary Sewer	15) Z		DIRECTOR
NW NATURAL City of Canby)Ĕ	₹\$	
CONTACT: Darrell Hammond CONTACT: Jerry Nelzen ADDRESS: 220 NW Second Ave ADDRESS: 1470 NE Territorial Rd, PO Box 930			R0AD 97045	
Portland, OR 97209 Canby, OR 97013			- ¥	
PHONE: 503.610.7746 PHONE: 503.266.0759 EMAIL: darrell.hammond@nwnatural.com EMAIL: nelzenj@canbyoregon.gov			RCREE TY, OR	
	L L	2 4 0	렸는	
BROADBAND		ዾኯ፟	Х Щ Х Ц Ц Х Ц Х	
WAVE			<u>зо</u> 1 1 1 1 1 1 1 1 1 1 1 1 1 1 1 1 1 1 1	
CONTACT: Robert Lee) 24	£₽₽	
ADDRESS: 669 Glatt Circle Woodburn, OR 97071				
PHONE: 503.707.1076				z
EMAIL: rlee@wavebroadband.com			N I	ß
			WE	Ŧ
		V	NS S	NOSNHOL
Proposed Sidewalk			Ŭ L L	DAN
Variable Depth Grind and 2" Inlay			•	
Full Depth ACP Repair	DESIGNED BY	COX COX	drafted BY: D. Shadrin	Checked By T. Roos
	ESIGN	J J	drafted by D. Shadrin	HECKI
Bark Mulch Installation		T		
Bark Mulch Installation Concrete Driveway Repair ACP Driveway Repair				
Concrete Driveway Repair				
Concrete Driveway Repair			d inlay	
Concrete Driveway Repair			and	
Concrete Driveway Repair			and	
Concrete Driveway Repair			and	
Concrete Driveway Repair		2	and	
Concrete Driveway Repair ACP Driveway Repair		>	and	
Concrete Driveway Repair ACP Driveway Repair		>	and	
Concrete Driveway Repair ACP Driveway Repair		>	and	
Concrete Driveway Repair ACP Driveway Repair	REVISIONS	2	sidewalk and pavement grind and	
Concrete Driveway Repair ACP Driveway Repair)	2 sidewalk and pavement grind and	
Concrete Driveway Repair ACP Driveway Repair)	Phase 2 sidewalk and pavement grind and	
Concrete Driveway Repair ACP Driveway Repair			Phase 2 sidewalk and pavement grind and	
Concrete Driveway Repair ACP Driveway Repair			Phase 2 sidewalk and pavement grind and	
Concrete Driveway Repair ACP Driveway Repair		DATE:	2 sidewalk and pavement grind and	
Concrete Driveway Repair ACP Driveway Repair			Phase 2 sidewalk and pavement grind and	
Concrete Driveway Repair ACP Driveway Repair)5.28 7	DATE:	4 4/29/2025 Phase 2 sidewalk and pavement grind and	


		Index of S	heets]			
Sheet Number	Sheet Title	Sheet Number	Sheet Title	1		ST PEDESTRIAN FION IMPROVEMENTS	
A01	Title Sheet	EB10 Thru EB17	Traffic Control Plan - Phase III	1		Ż	002
A02	Title Sheet	FB01Thru FB08	Grading and Erosion Control			∠₩	01-300317300
A03	Plan Sheet Layout	LA01 Thru LA04	Sign Installation Plan			PEDESTRIAN N IMPROVEM	2002
A04	Survey Control Data	LB01 Thru LB05	Sign Details			<u>E</u>	1
BA01 Thru BA05	Typical Sections	MA01	Signal Legend		F	S ST	
BB01 Thru BB04	Details	MB01-A Thru MB02	Signal Plan	1	TITLE SHEET	Ш'n	
BC01Thru BC30	Curb Ramp Details	MC01 Thru MC05	Signal Details	1	SH	ΞΩ	E
BD01 Thru BD06	Drive Way Grading Details	QA01 Thru QA05	Pavement Marking Plans	1	щ		PRO.IFCT
BE01Thru BE08	Intersection Grading Details	QB01Thru QB03	Pavement Marking Details		E	15) ad
C01Thru C10	General Construction	40000		1		TION	L
EA01Thru EB01	Traffic Control Plan - Details			-		≻ਠ	r K
EB02Thru EB09	Traffic Control Plan - Phase II			-		S IVY 3SEC	r 2023
JTILITY C	ONTACTS		1	J		S IVY S	December
WATER/ELECTR		COMMUNICA	TIONS			ż	
CANBY UTILI		DIRECT LIN				=	DATE.
CONTACT: Jas			Eric Kehler				۲ I
ADDRESS: 126	55 SE 3rd Ave, 1by, OR 97013		190 SE 2nd Ave Canby OR 97013				
	3.263.4307		503.266.8223		∥≻		۲ ۲
	erning@canbyutility.org		eric.kehler@cbsoregon.com		E		DIRECTOR
-					∥⊇	-	ШЖ
GAS NW NATURAL		Sanitary Sew City of Canb			ΠС	2 00	⊡
	rrell Hammond		Jerry Nelzen			RANSPORTATION OPMENT RCREEK ROAD TY, OR 97045	
) NW Second Ave		1470 NE Territorial Rd, PO Box 930		MAS	8 <u> </u>	
	tland, OR 97209 3.610.7746		Canby, OR 97013 503.266.0759		l	^x 전 집 R	
	rell.hammond@nwnatural.com		nelzenj@canbyoregon.gov		∣⊴	¥ep5×	
					ll 곳	~ 럭 = =	
BROADBAND					₽	° Ä Ä S	
WAVE					L ا	R S S P T	
	bert Lee 9 Glatt Circle				$\ O$	84#5	
	odburn, OR 97071						
	3.707.1076						7
EMAIL: rlee	e@wavebroadband.com					Ŋ	N I
							Ž
roposed Sidewall	k						NOSNHOL
ariable Depth Gr						1 0	DAN
III Depth ACP Rep					ж	Sin	× ۵,
ark Mulch Installa					DESIGNED BY:	C. COX DRAFTED BY D. SHADRIN	CHECKED BY
oncrete Driveway	/ Repair				DES	_ <u>ह</u>	3
CP Driveway Rep	air						
, ,						≥	
						id inlay	
						d and	
						grin	
					6	ent	
		_			REVISIONS	/em	
			ED DDOC		<u>0</u>	l pa	
			TEREDFHUFESC		l S	and	
			NGINEE	2	Ш	alk alk	
			ENGINEER 60404PF	乞 \	Ē	lidev	
			60404PE	<u> </u>		5 2 S	
			Digitally Signad	25.05.28		Phase 2 sidewalk and pavement grind	
				∠o.∪o.28			\square
	KITTEI	SON	OREGON /			DATE: 4/29/2025	
	& ASSOC	ATEC		_ /		DATE: 4/29/202	
		AIC3	жил но NY M. RO				\square
	851 SW 6TH AVENUE, S		HONY M. RO	/		NO. ₽	
	PORTLAND, OR 97204				Shee	<u> ~ </u> ∋t No.	
		977 0160				A02	
1	P 503.228.5230 🛛 🖛 503	.273.8169	EXPIRES: 12/31/2026				

LEGEND							
	- 251	Existing Minor Contour	S	Existing Sanitary Manhole	PUE	Proposed Public Utility Easement	Proposed Sidewalk
	- 250	Existing Major Contour	D	Existing Storm Manhole	PSUE	Proposed Public Utility and Slope Easement	
	- т ———	Existing Telephone Line		Existing Storm Curb Inlet	PSE	Proposed Slope Easement Temporary Construction Easement	Variable Depth Grind and 2" Inlay
	CTV	Existing Cable TV Line	Θ	Existing Water Valve		 Proposed Right Of Way 	 Full Depth ACP Repair
	SS	Existing Sanitary Line	Y	Existing Fire Hydrant	251	Proposed Minor Contour	
	(SSFM)	Existing Sanitary Forced Main Line		Existing Water Meter	250	Proposed Major Contour Proposed Curb/Gutter	Bark Mulch Installation
	- w	Existing Waterline	\sim	Existing Street Light		Proposed Lighting Conduit	Concrete Driveway Repair
	OHW	Existing Overhead Wires	-0- ´	Existing Utility Pole		Proposed Storm Sewer Pipe	
		Existing Underground Power Lines	2	Existing Guy To Utility Pole		Proposed Sawcut Line	ACP Driveway Repair
i		Existing Underground Traffic Signal Lines	O GV	Existing Gas Meter	C	 Proposed Grading Daylight - Fill Proposed Grading Daylight - Cut 	
		Existing Fiber Optic Line	GV	Existing Gas Valve	D)	Proposed Storm Manhole / Drywell	
— x –		Existing Wire Fence Line		Existing Sign		Proposed Storm Inlet	
		Existing Right Of Way		Existing Mail Box			
· · · ·		Existing Storm Sewer Line		Existing Telephone Junction Box (Riser)		Proposed Signal Pole	
			T	Existing Telephone Manhole	•	Proposed Utility Pole Mounted Street Light	
	- G	Existing NW Natural Gas Line	\boxtimes	Existing Signal Controller Cabinet		Proposed Pedestrian Signal Pole	
[Existing Public Easement		Existing Signal Junction Box		Proposed Junction Box	
		Existing Berm Top of Bank		Existing Survey Monument			
	$\checkmark \checkmark \checkmark \checkmark \checkmark$	Remove/Abandon Existing Pipe	×	Existing Tree Removal			
	M	Existing Deciduous/Coniferous Tree					
1 w	\vee \vee	J					




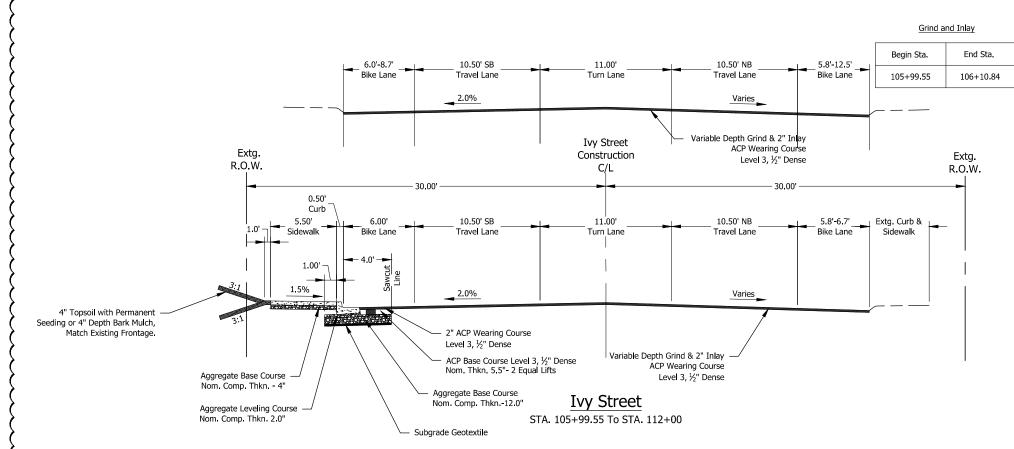


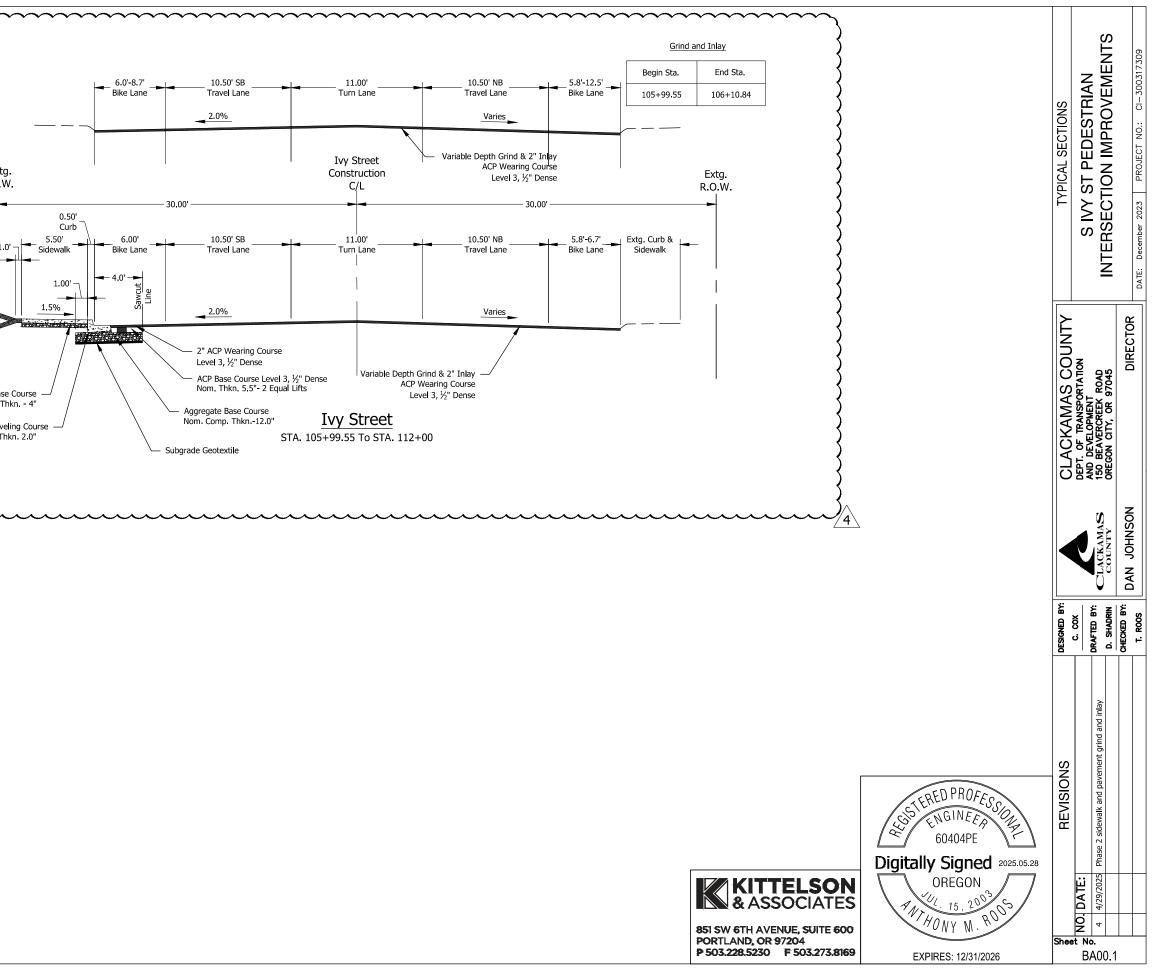

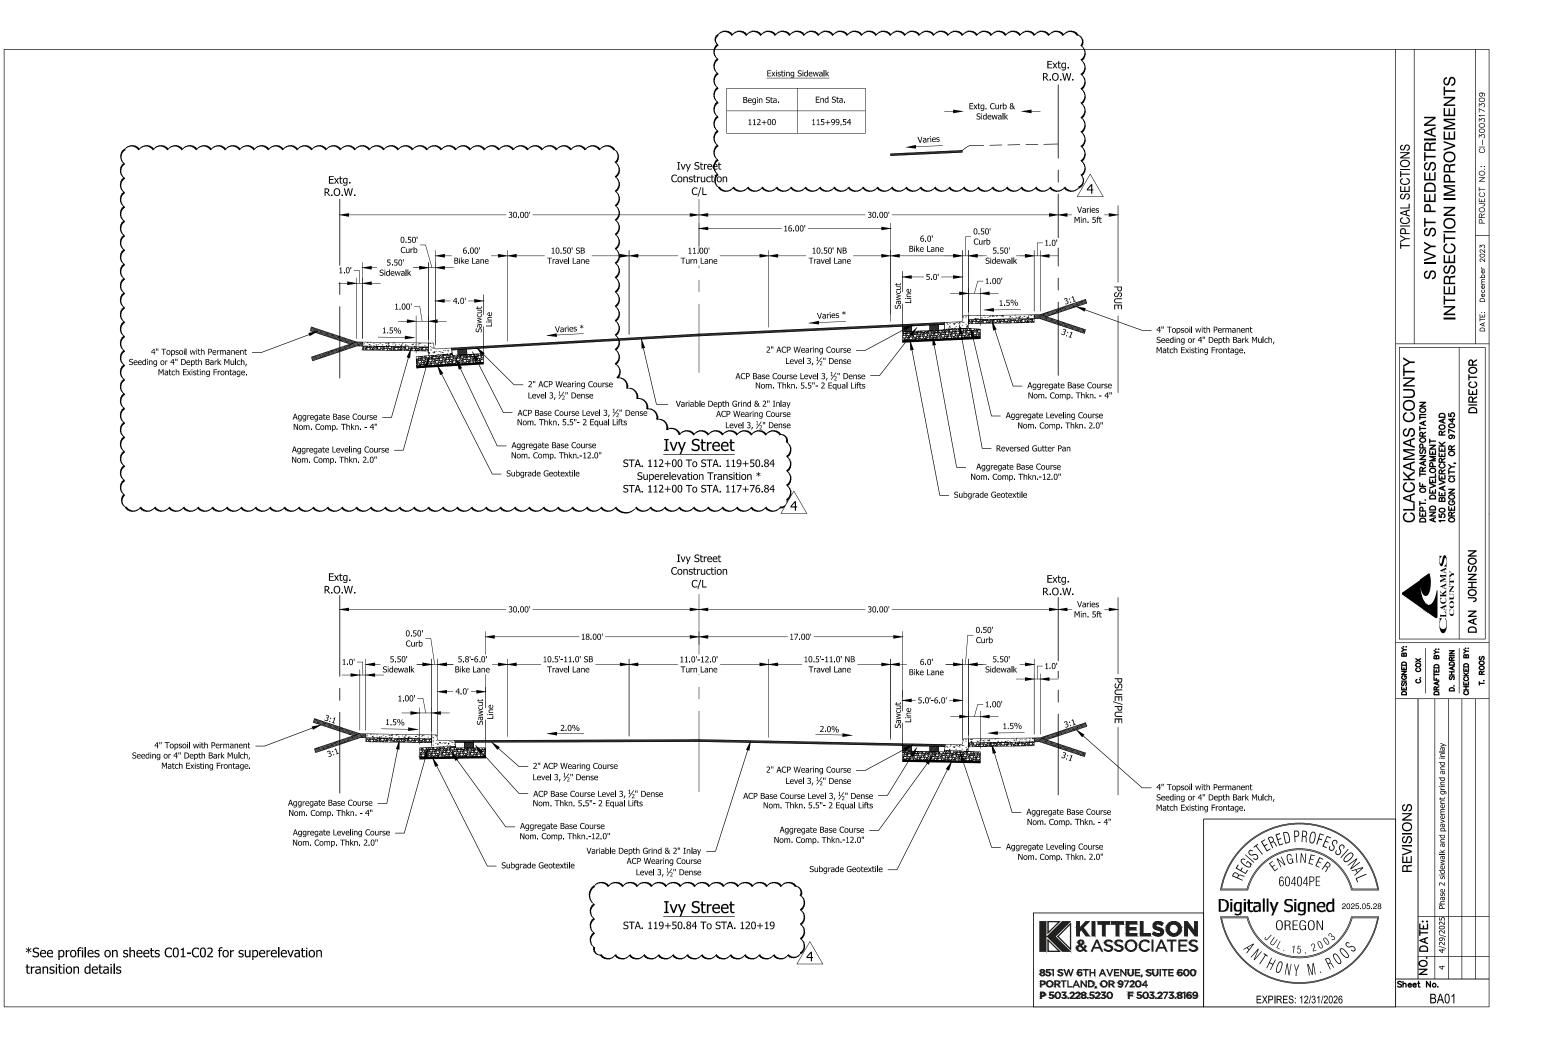


Plot Stamp: 5/26/2025 12:43:39 PM - Dimitryan Shadrin File: H:/23/23982 - I.yy Street Pedestrian Improvements/design_CD\BA-TYPICAL SECTIONS.dw

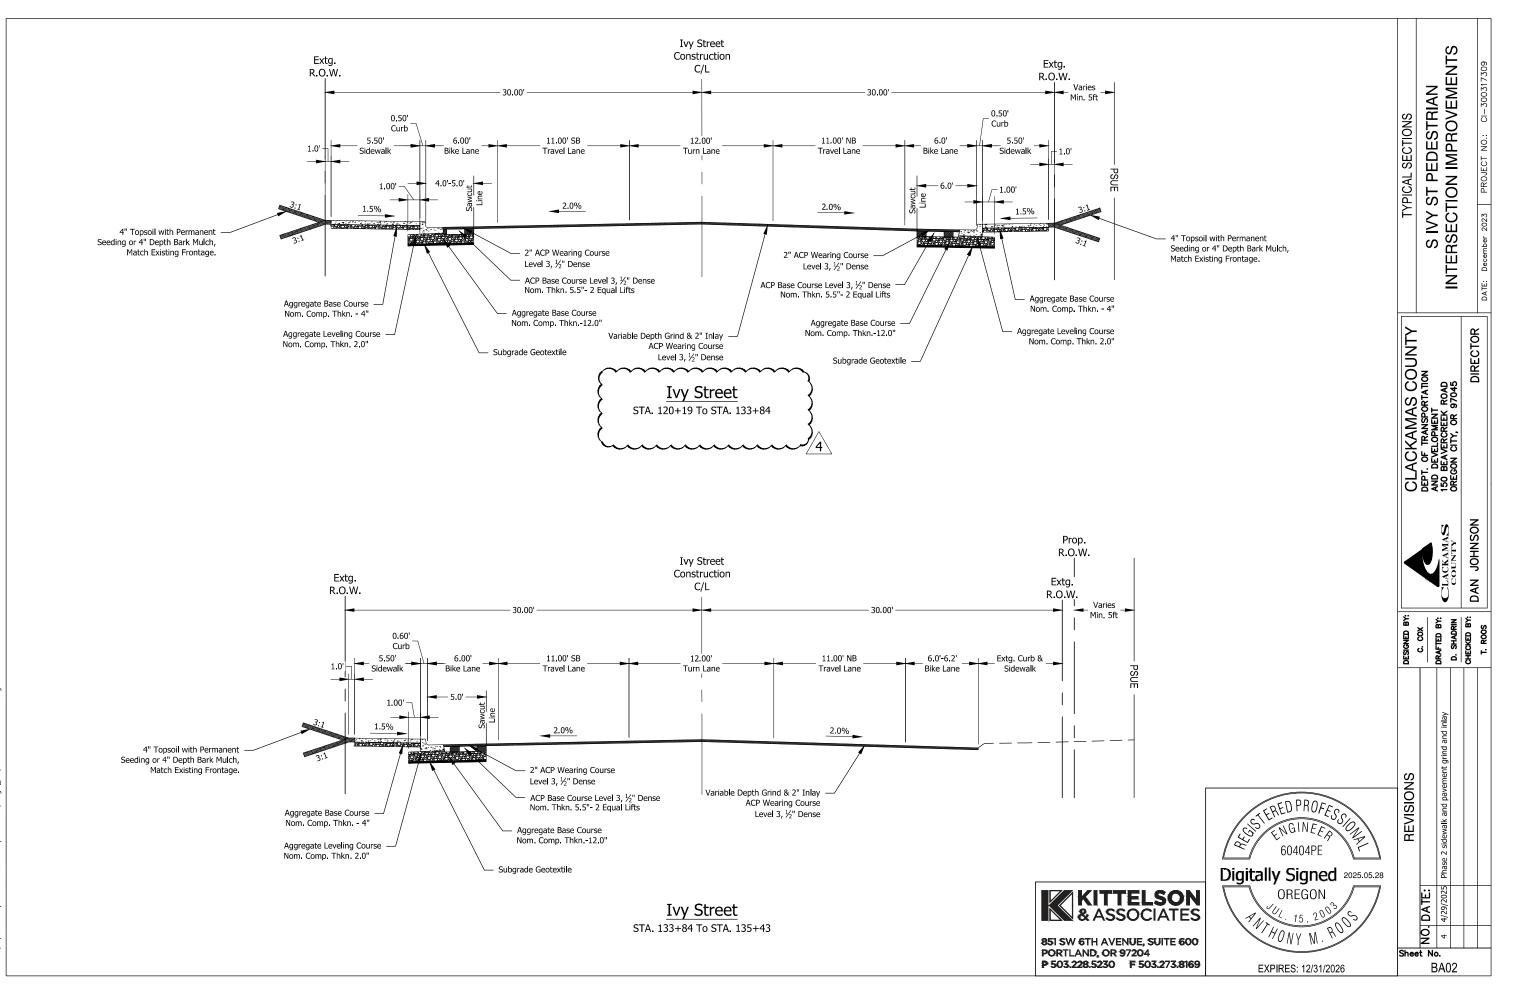


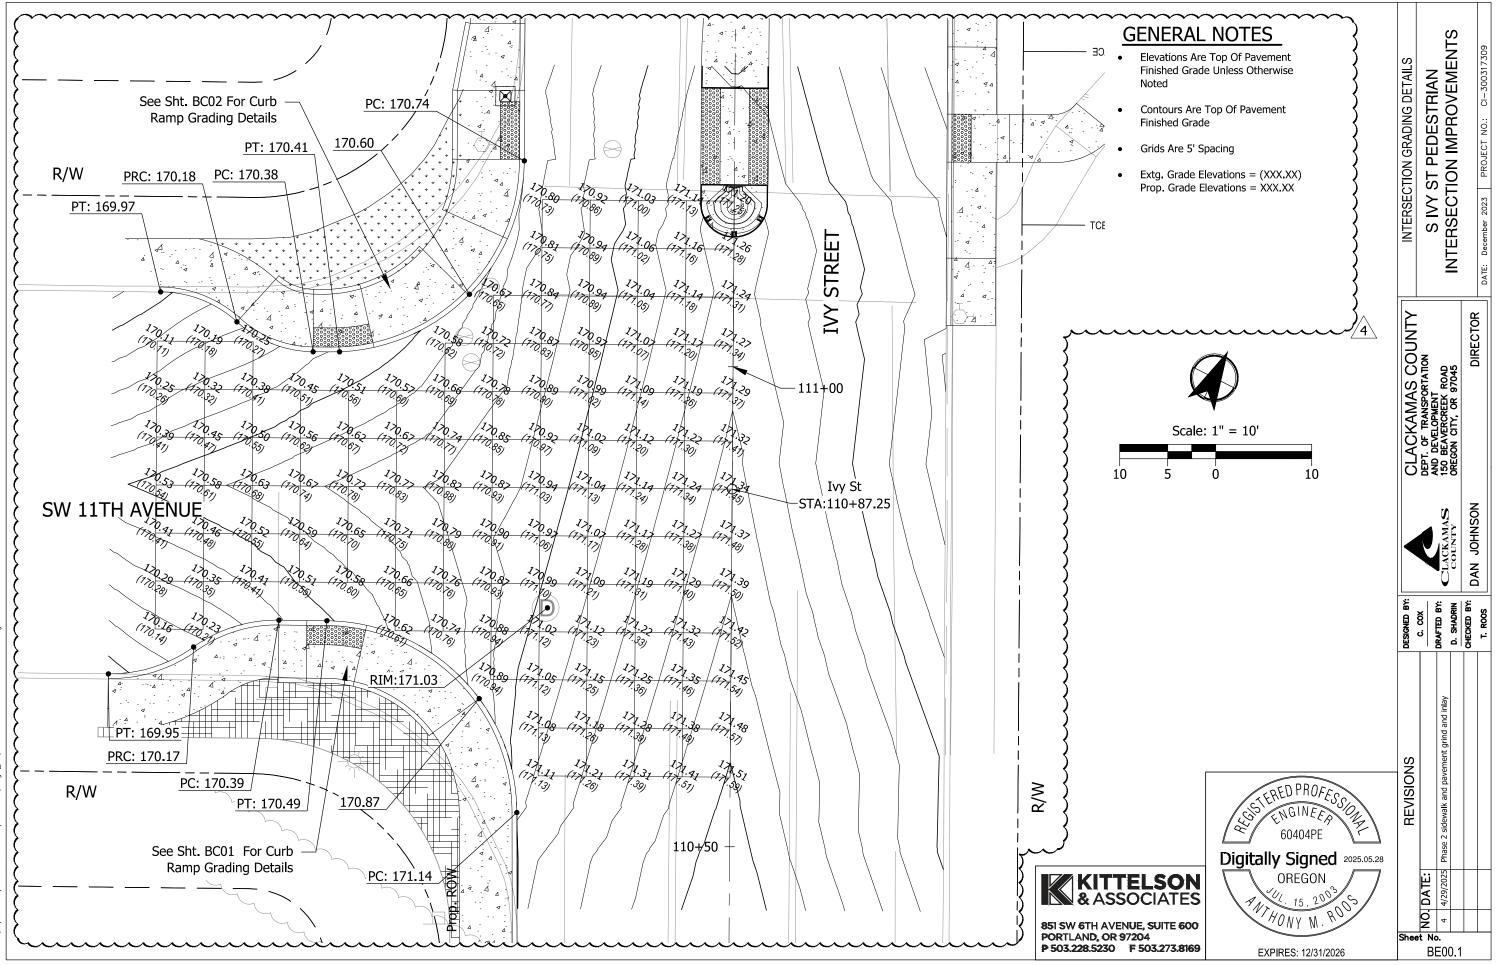

Plot Stamp: 5/26/2025 12:44:29 PM - Dimitryan Shadrin File: H:\23\23982 - Ivy Street Pedestrian Improvements\design_CD\BE-INTERSECTION GRADING DETAIL

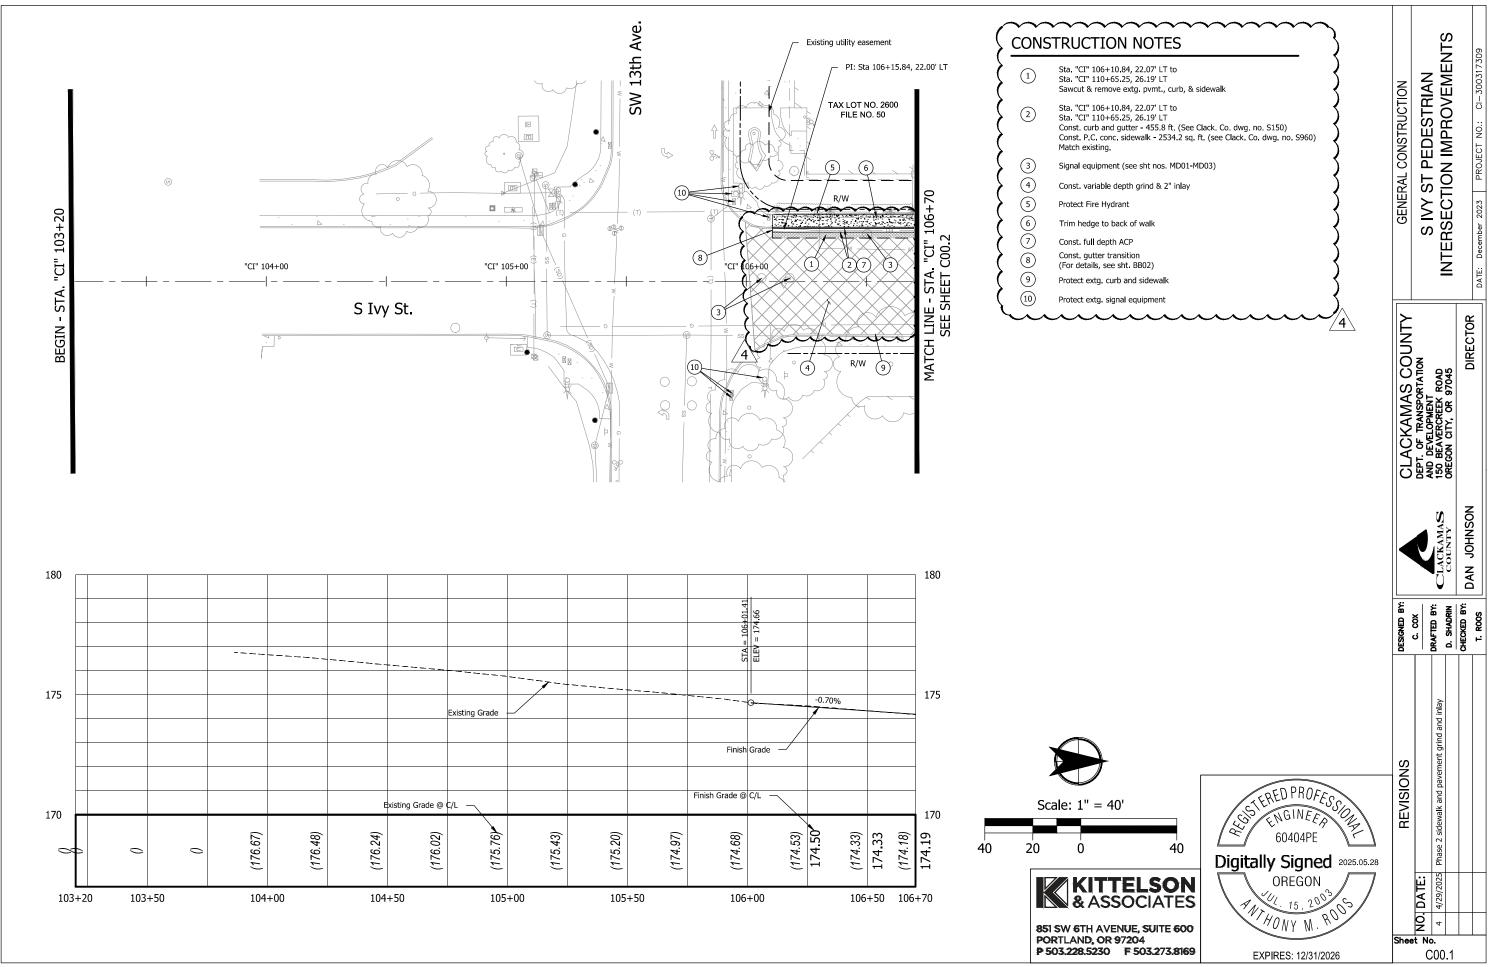


Plot Stamp: 5/26/2025 12:44:54 PM - Dimitryan Shadrin File: H:\23\23982 - Ivy Street Pedestrian Improvements\design_CD\C-PLAN & PROFILE_PH2.d

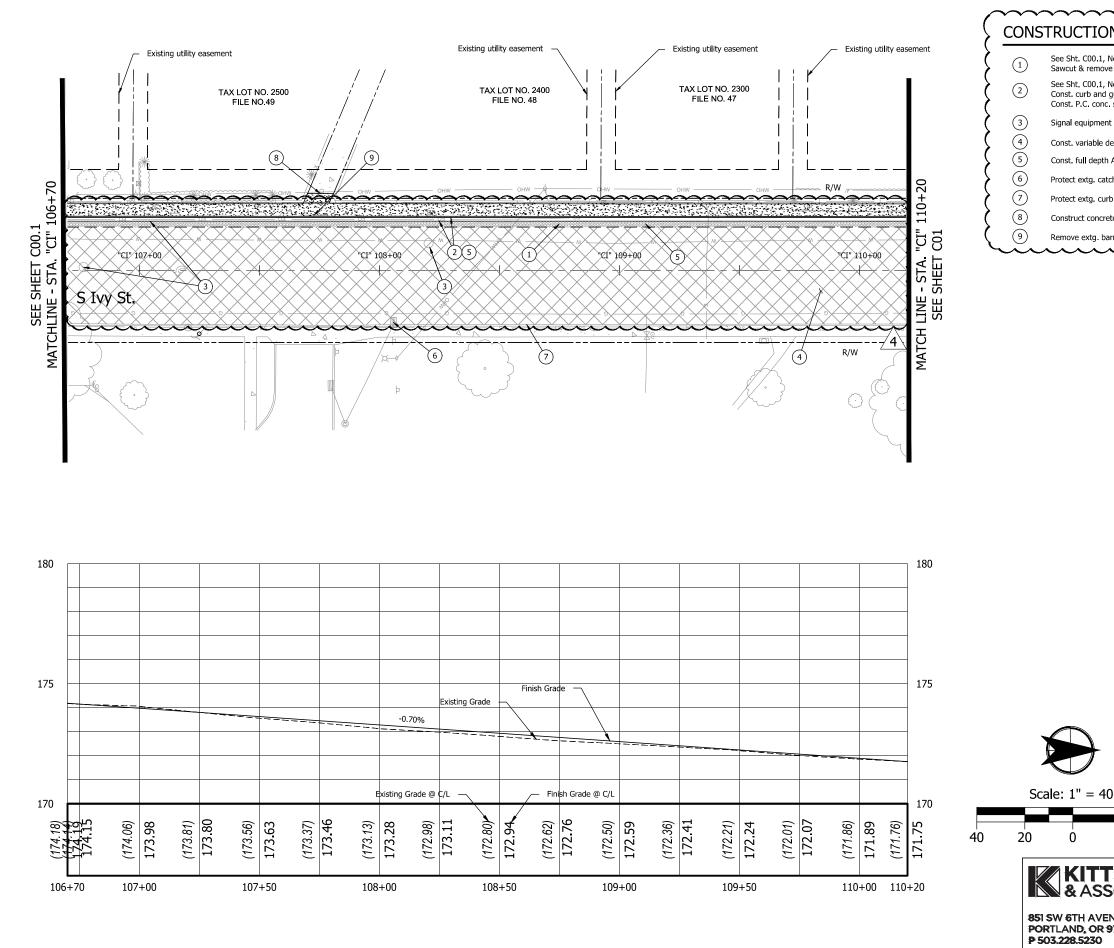



Plot Stamp: 5/26/2025 12:45:31 PM - Dimitryan Shadrin File: H:\23\23982 - Ivy Street Pedestrian Improvements\design_CD\C-PLAN & PROFILE_PH2.dr

NUTUES Number 1 Number 2 N					
0' 40 CICION 1: DO DIGICALINS DIGICAL	N NOTES	}		VTS	6
0' 40 TELSSONS SOCIATES SOCIATES SOLUTION 40 TO TO TO TO TO TO TO TO TO TO	ve extg. pvmt., curb, & si Note 2 gutter sidewalk ht (see sht nos. MD01-MI depth grind & 2" inlay h ACP tch basin rb and sidewalk ete path connection, mat	2003)	GENERAL CONSTRUCTION	S IVY ST PEDESTRIAN INTERSECTION IMPROVEMEN	December 2023 PROJECT NO.:
0' 40 Sociates NUE, SUITE 600 97204 Sheet No.			CLACKAMAS COUNTY	DEPT. OF TRANSPORTATION AND DEVELOPMENT 150 BEAVERCREEK ROAD OREGON CITY, OR 97045	DIRECTOR
0' 40 ELSON SOCIATES NUE, SUITE 600 97204 Sheet No.				CLACKAMAS	DAN JOHNSON
TELSON OREGON SOCIATES V////.15.203 ENUE, SUITE 600 V////.15.203 97204 Sheet No.			DESIGNED BY:	C. COX DRAFTED BY: D. SHADRIN	CHECKED BY: T. ROOS
TELSON OREGON SOCIATES V////.15.203 ENUE, SUITE 600 V////.15.203 97204 Sheet No.		DEN PROEZ-	SIONS	rd pavement grind and inlay	
97204 Sheet No.	40 TELSON	Digitally Signed 2025.05.28	REVIS		
	97204		Shee	l∠ et No.	

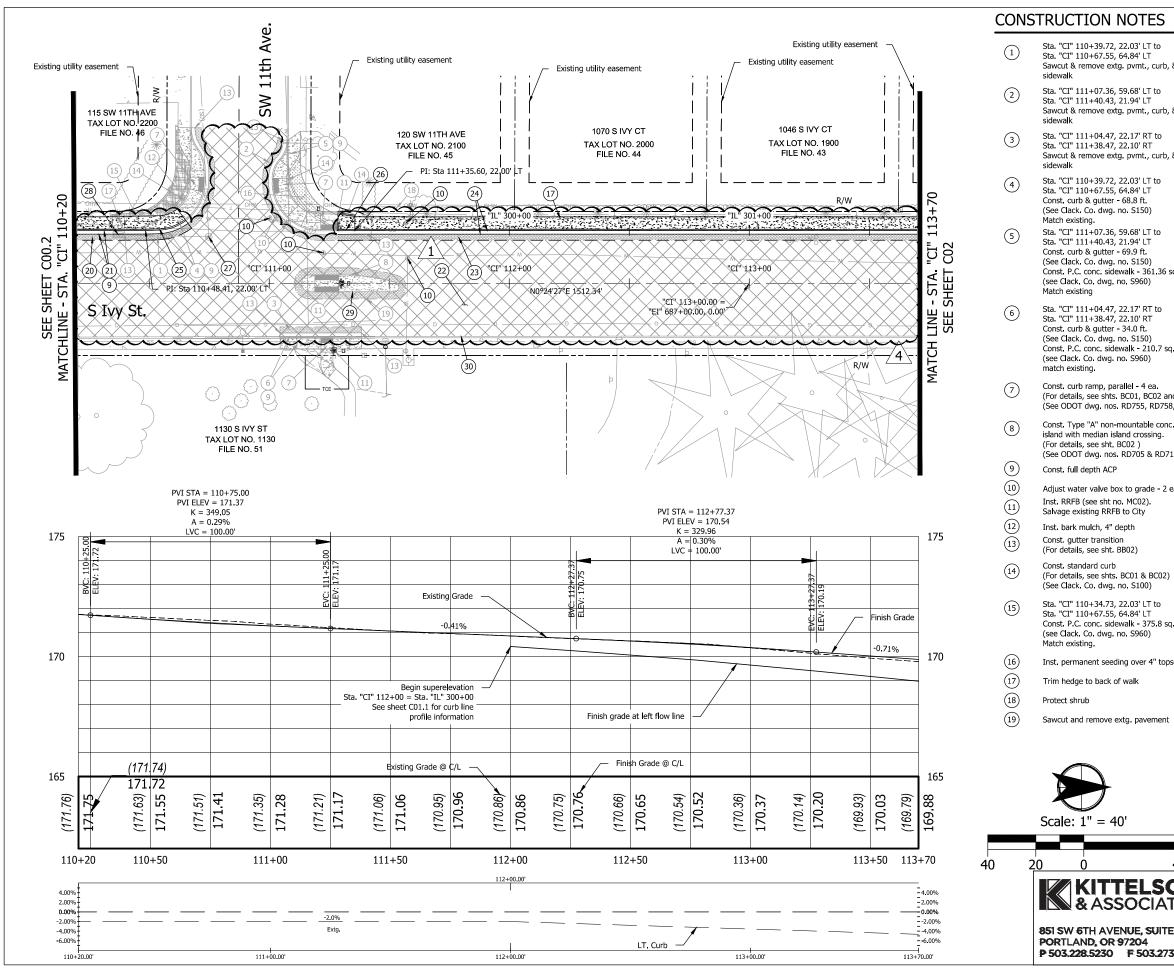


Plot File:

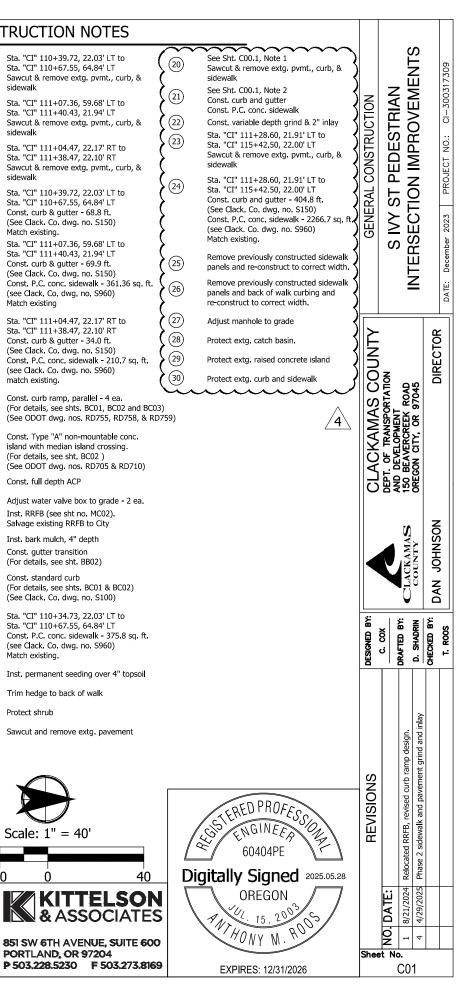


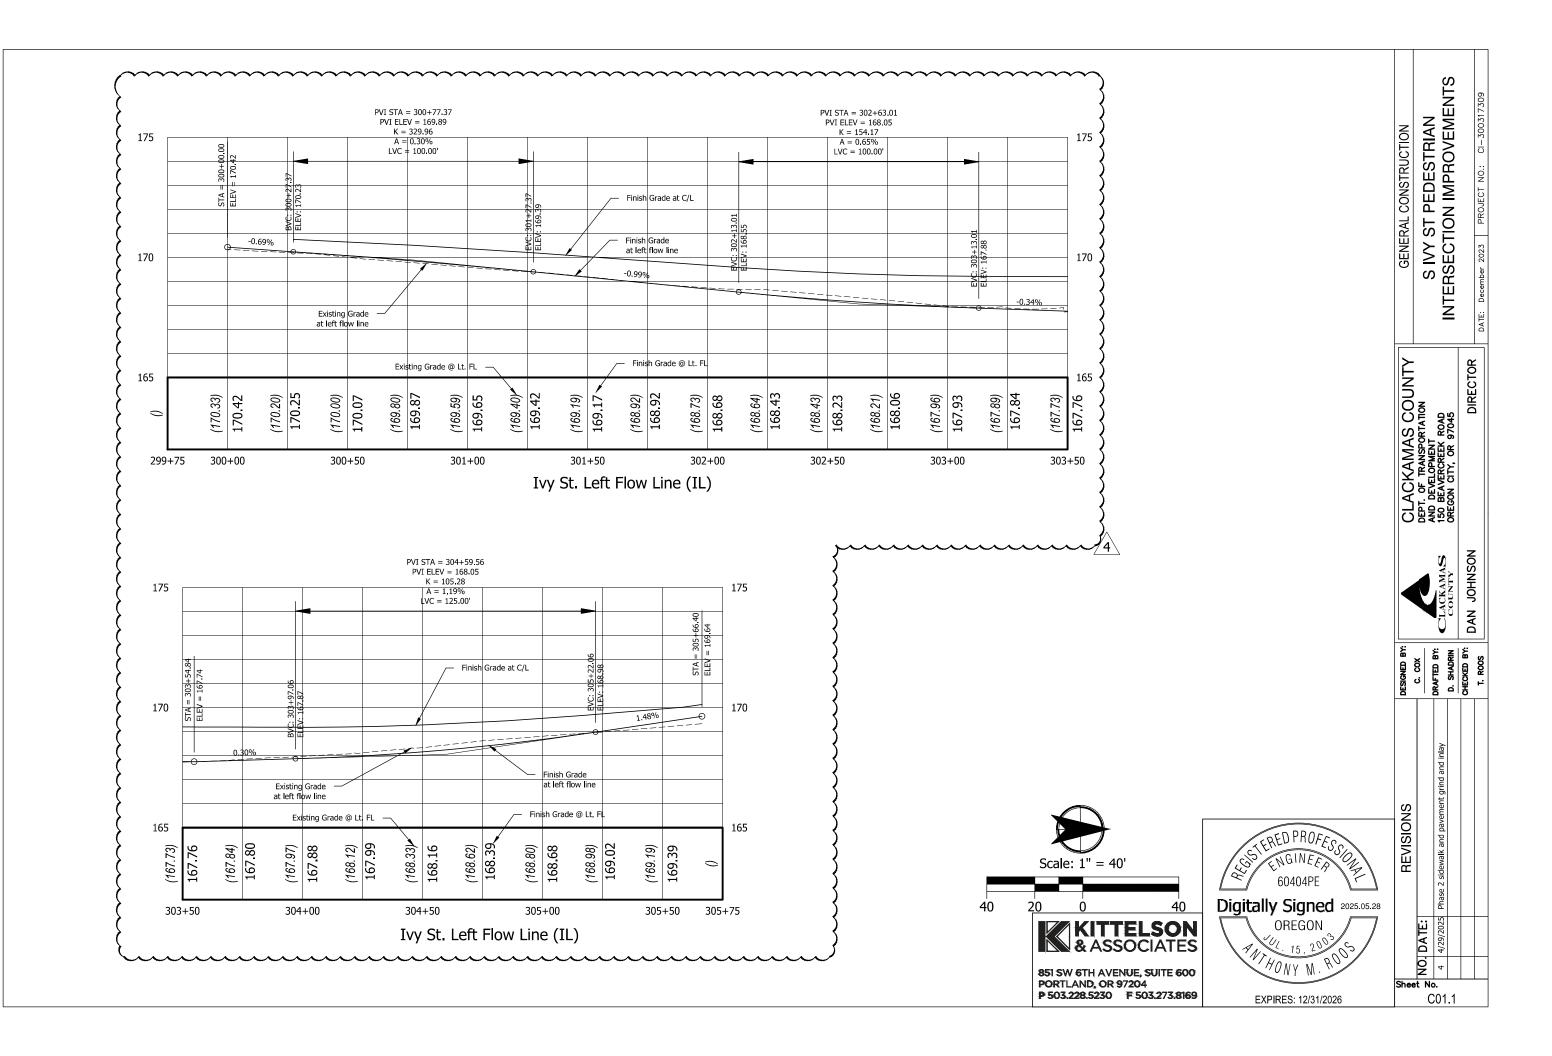


Plot Stamp: 5/26/2025 12:46:35 PM - Dimitryan Shadrin File: H:\23\23982 - Ivy Street Pedestrian Improvements\design_CD\C-PLAN & PROFILE_PH2.

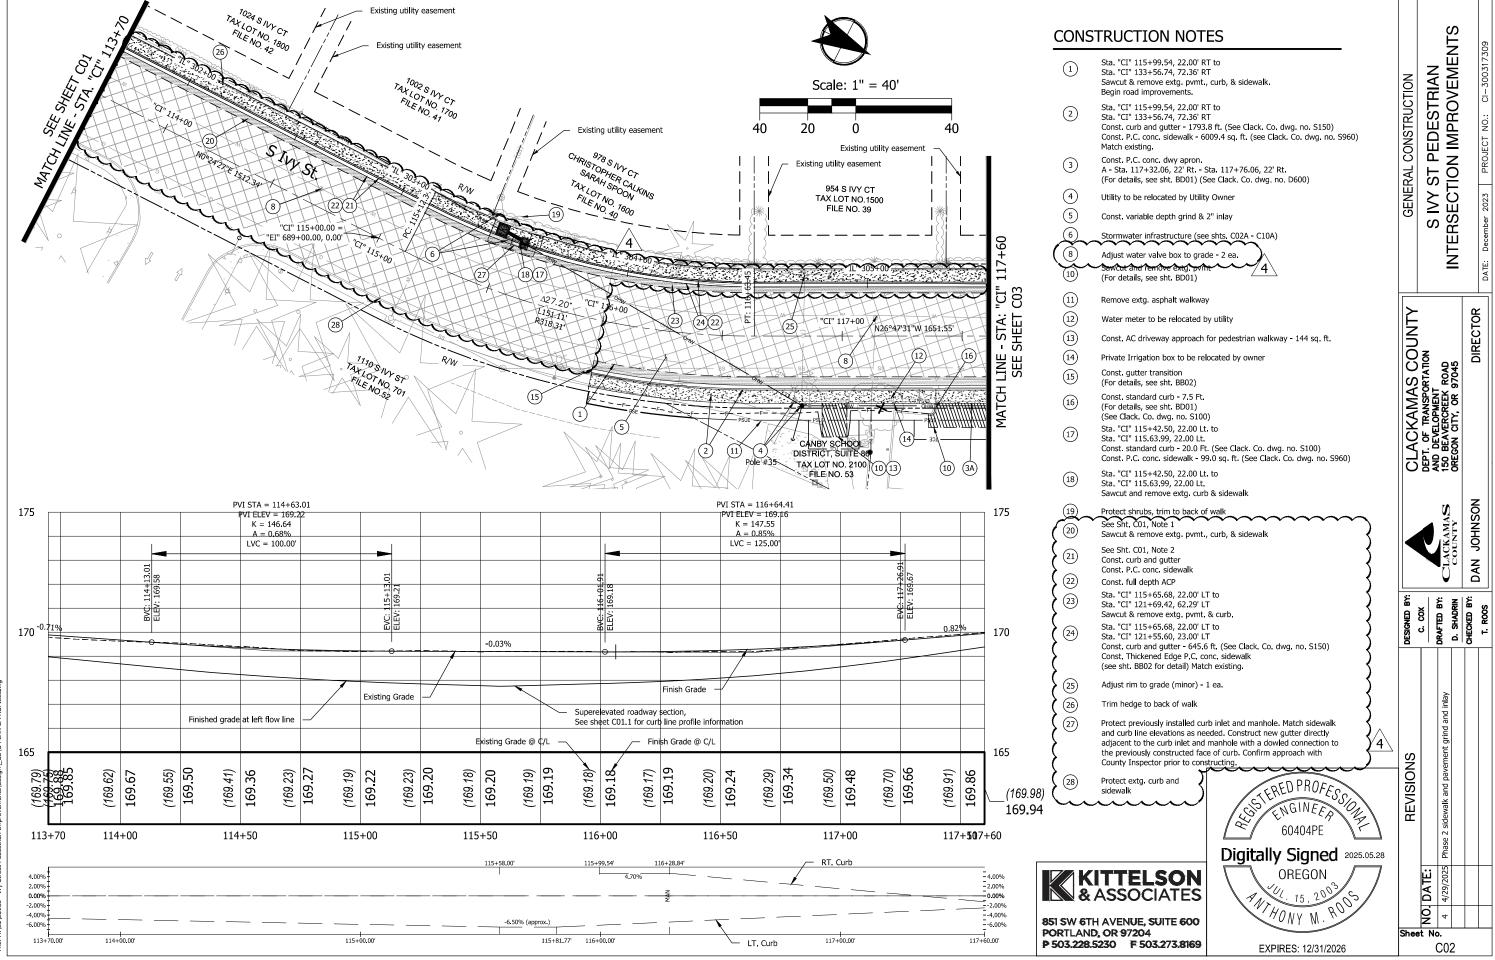



Plot File:

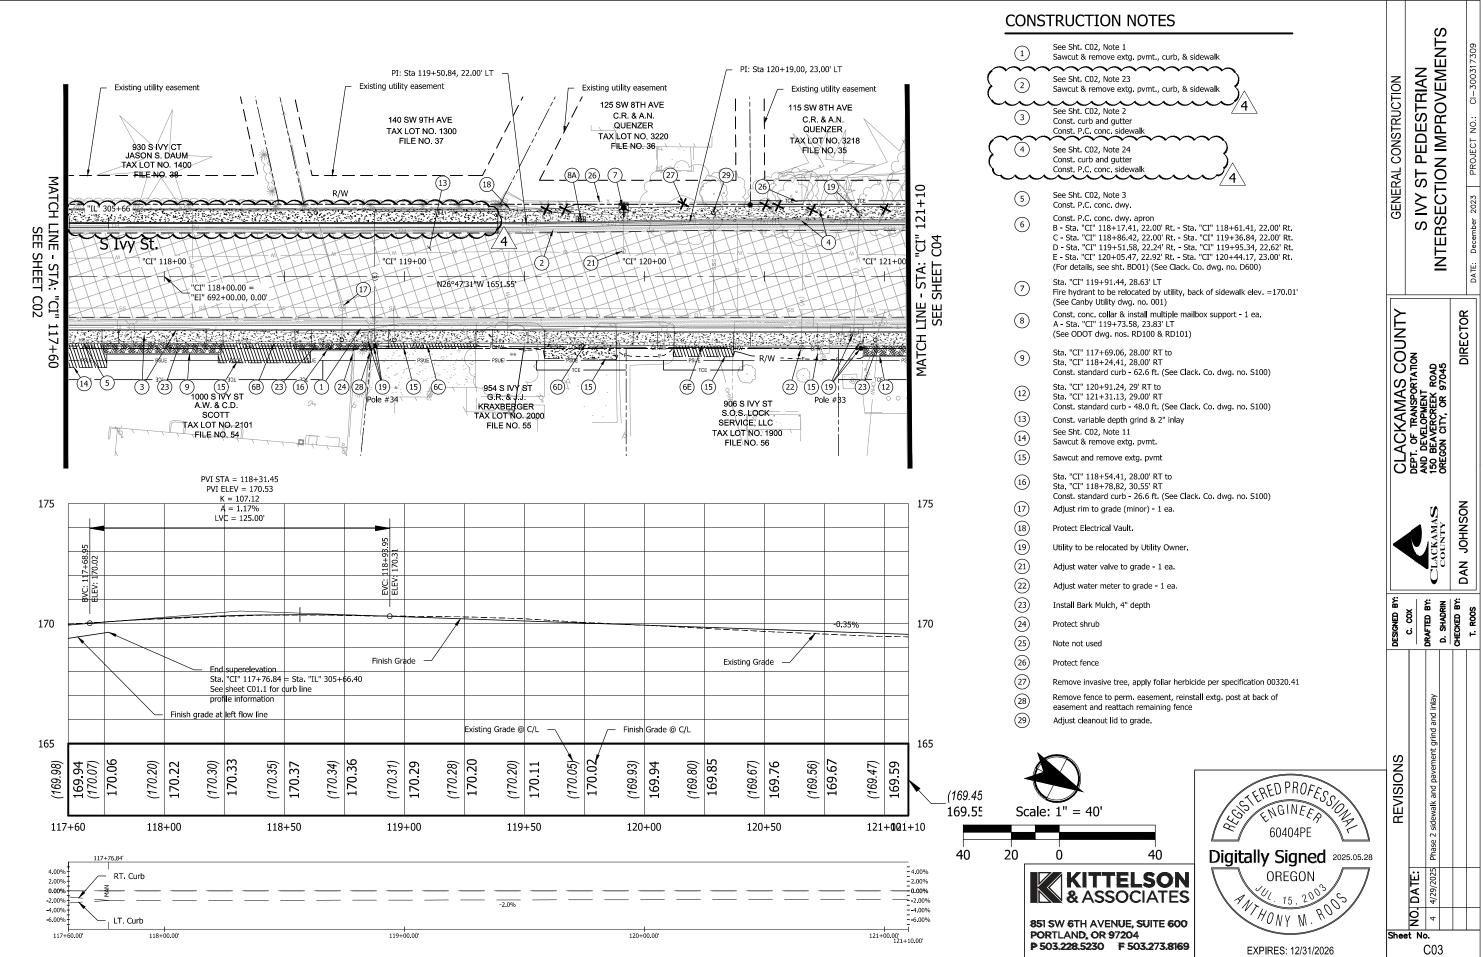


Plot File:

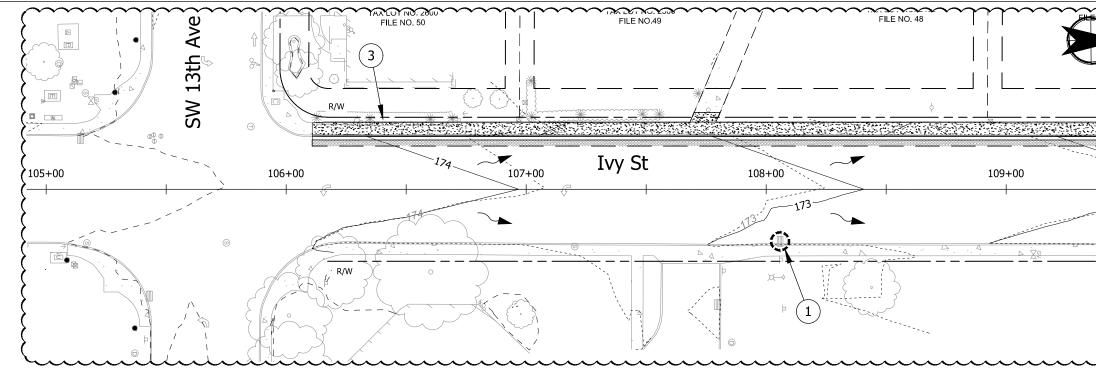

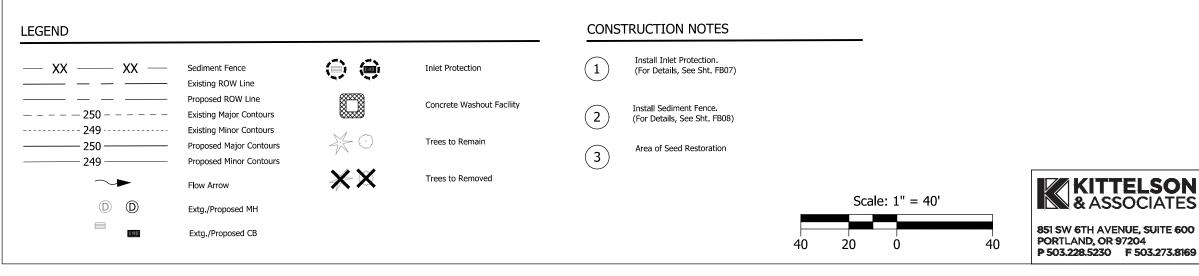

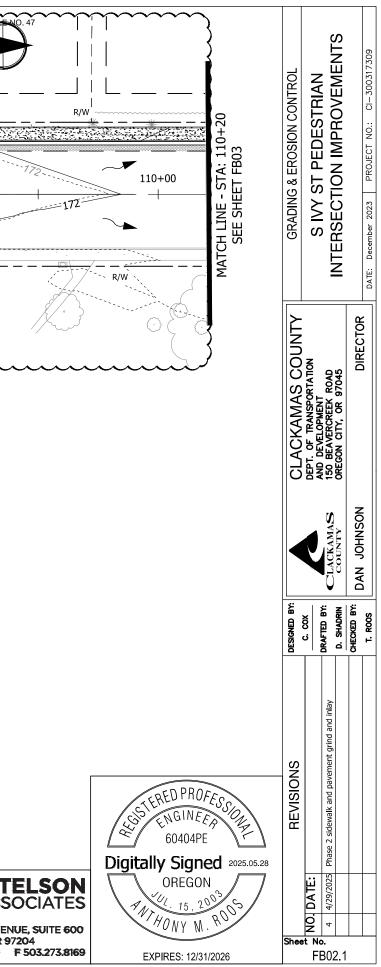

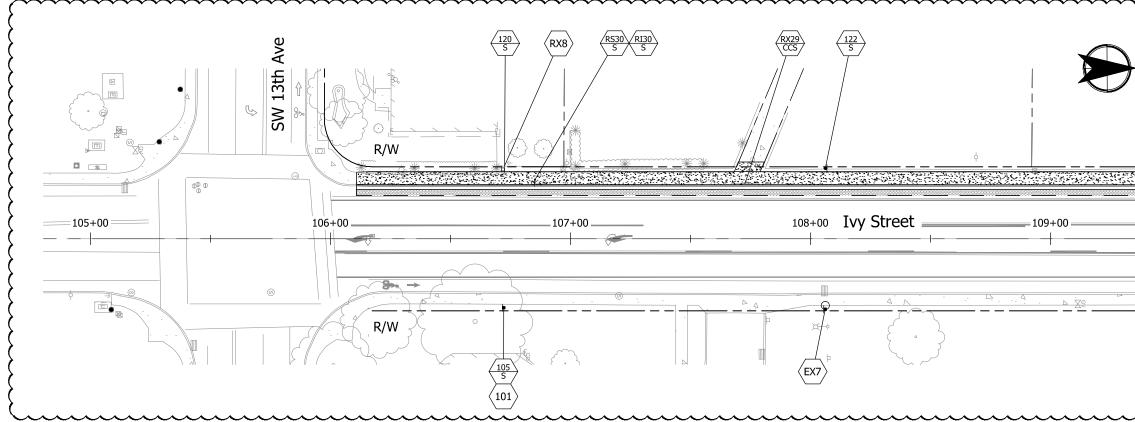

SIGNING LEGEND

N INSTALL NEW SIGN (N).

 $\left< \frac{N}{M} \right>$ INSTALL NEW SIGN (N) ON NEW (M) SIGN SUPPORT.

 $\langle EXN \rangle$ RETAIN AND PROTECT EXISTING SIGN (N) AND SUPPORT.

 $\left< \frac{RXN}{M} \right>$ REMOVE EXISTING SIGN (N) AND (M) SIGN SUPPORT.

 $\langle RXN \rangle$ REMOVE EXISTING SIGN (N) FROM EXISTING SIGN SUPPORT.

 $\left< \frac{RIN}{M} \right>$ REINSTALL EXISTING SIGN (N) ON NEW (M) SIGN SUPPORT.

REMOVE AND SALVAGE EXISTING SIGN (N) AND REMOVE (M) SIGN SUPPORT.

(RRFB) INSTALL RRFB (SEE SIGNAL PLAN).

> N = SIGN NUMBER M = MATERIAL OPTIONS ARE:


S = PERFORATED STEEL SQUARE TUBE SIGN SUPPORT (SEE ODOT STD. DWG. TM687, 2" OPTIONAL ANCHOR DETAIL) CCS = CROSSWALK CLOSURE SUPPORT (SEE DETAIL ON SHT. LB05)




- 1. ALL SIGNING SHALL CONFORM TO THE REQUIREMENTS AND SPECIFICATIONS OF THE MANUAL ON UNIFORM TRAFFIC CONTROL DEVICES (M.U.T.C.D) 2009 EDITION, AND THE OREGON SUPPLEMENT TO THE MUTCD
- 2. THE LOCATIONS OF SIGN INSTALLATIONS SHOWN ARE APPROXIMATE WITH THE EXACT LOCATIONS TO BE DETERMINED IN THE FIELD.
- 3. EXISTING SIGNS NOT SHOWN ARE TO REMAIN IN PLACE UNLESS OTHERWISE DIRECTED.
- 4. REFER TO CITY OF CANBY STD. DWG. NO.111 FOR LETTER HEIGHT ON STREET NAME SIGNS.
- SIGNS LOCATED ON TRAFFIC SIGNAL POLES REFERENCE THE SIGNAL 5. DESIGN PLANS.
- 6. TRAFFIC SIGN LEGEND AND MOUNTING DETAILS ARE SHOWN ON SHEETS LB01 THRU LB03.




Scale: 1" = 40'

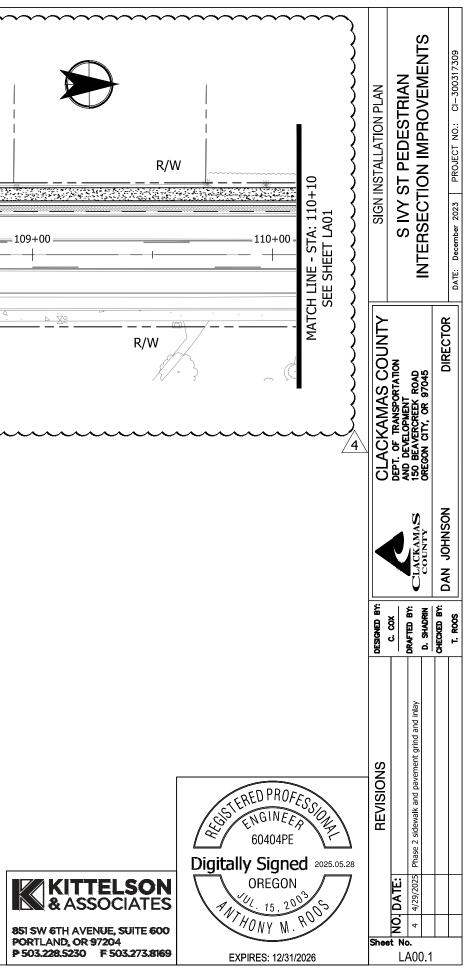

40

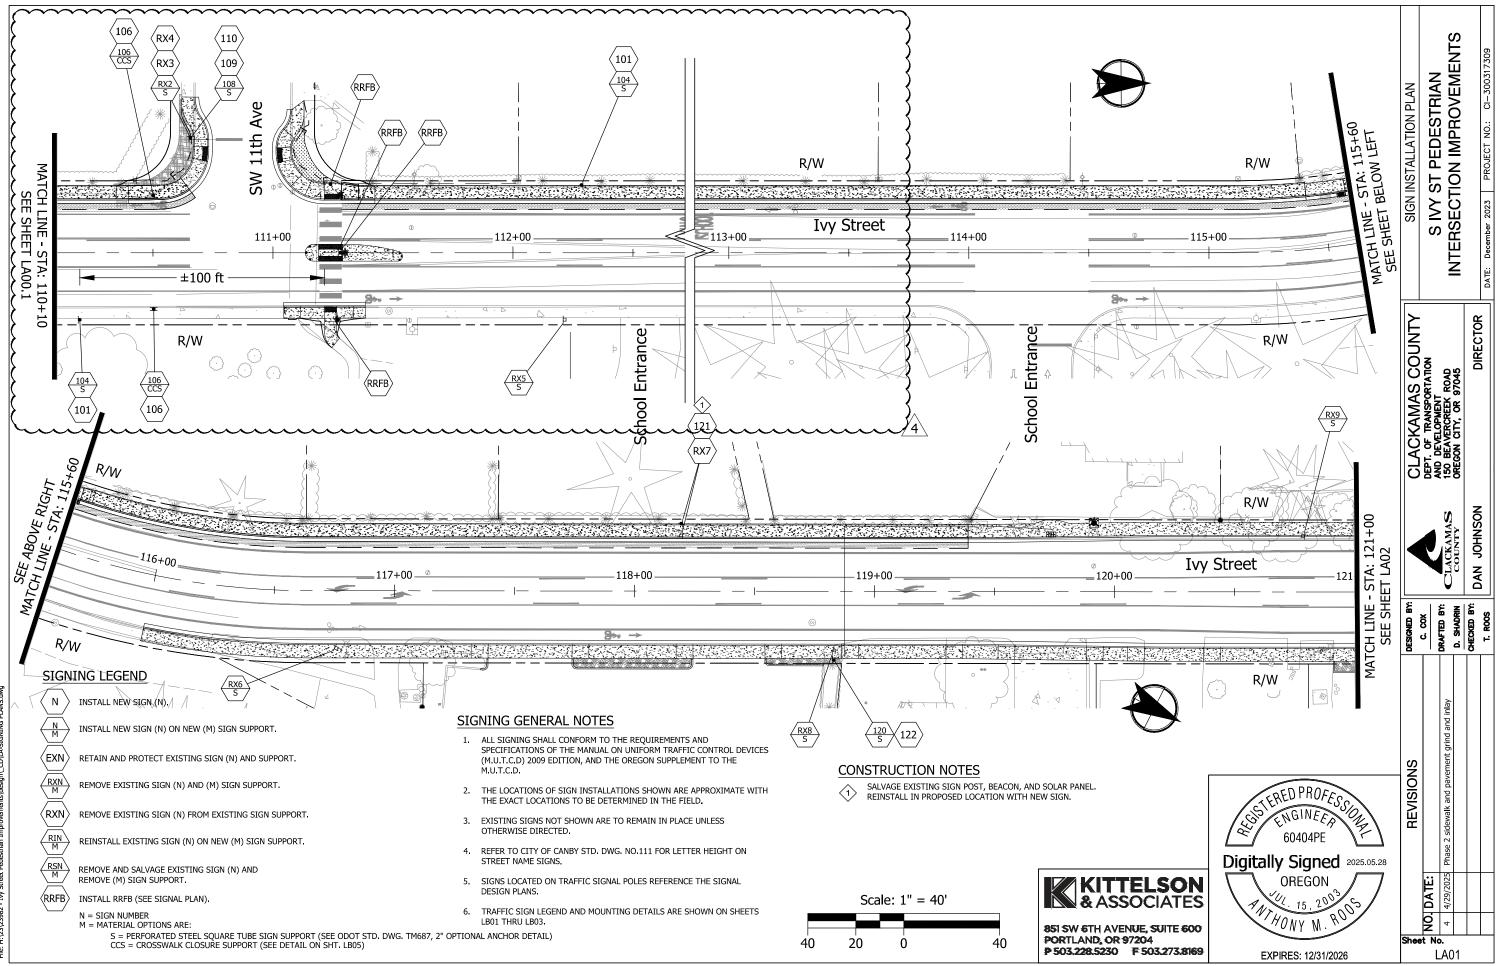

Plot File:

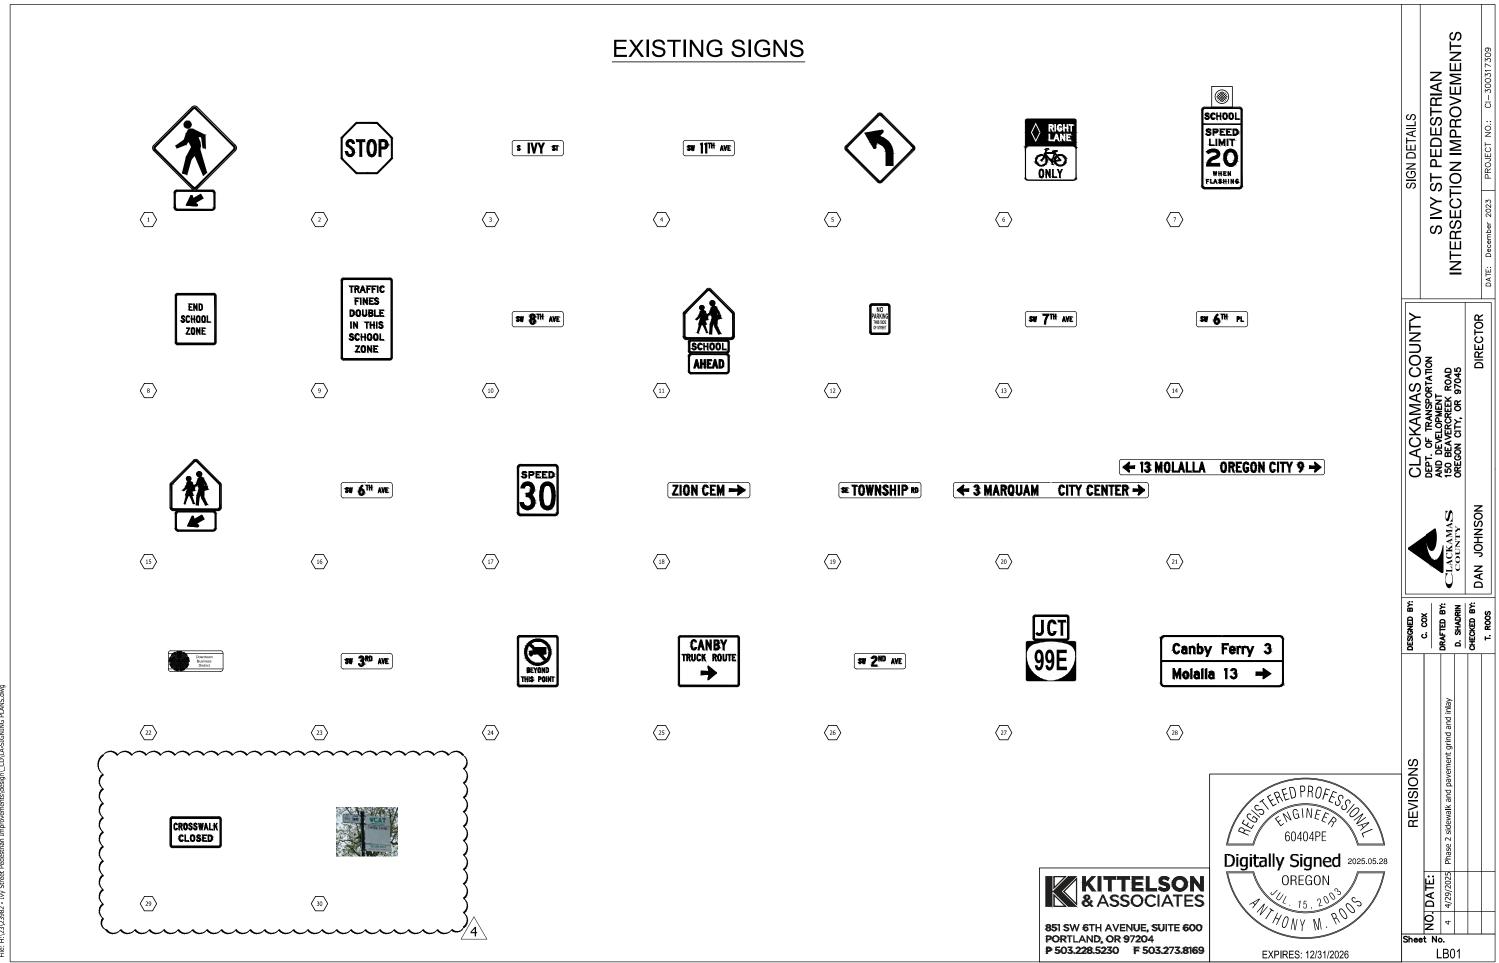


Plot Stamp: 5/26/2025 12:49:09 PM - Dimitryan Shadrin File: H:\23\23982 - Ivy Street Pedestrian Improvements\


SIGN	SIGN LOCATIO	N	SIG			SUB-			COLO	R <u>1</u> /		LEGE	NED	SIGN								TYP	PEOFS	SUPPOR	т		ш			accont		POST		1.00		TING			REMAR	RKS			S
NO.	<u>4</u> /		DIMENS	SIONS	ST	RATE	BAC	CKGROL	IND	LEGE	ND			NO. 2/	M671.	WAY			(SSC)								RICAD		ц		DARY SIGN 6 & TM678)	SIZE	LENG		3/ 3/	MIN. DEP TH	5/						
	(TM200-TM2 TM635)		VIDTH	HEGH.	PLYWOOD	SHEET ALUMINUM EXTRUDED ALUM. (TM675)	ASTM TYPE III OR	TYPE IV	TM TYPE	TYPE IV ASTM TYPE IX	NON-REFLECTIVE	PERMANENT	REMOV ABLE (TM230-TM233)		WOOD POST (TM670-TM671, TM676) SQ. TUBE SIGN SUPPORT (T	TM676, TM681, TM687-TM689) TRIANGULAR BASE BREAKA	(TM602) H-FRAME	MULTI-POST BREAKAWAY (TM220_TM600_TM601)	MP	SIGNAL POLE MOUNT (TM680)	MAST ARM SIGN MOUNT (TM679)	BRIDGE STRUCTURE MOUNT (TM677)	CANTILEVER / BUTTERFLY (TM622-TM627)	SIGN BRIDGE (TM606-TM612, TM614-TM620) EXIT NUMBER SIGN MOUNT	(TM220, TM225) ROUTE MARKER FRAME	(TM678) MILEPOST MARKER POST	(TM221-TM222) CROSSWALK CLOSURE BAR (TM490)	(1111450) VERTICAL SIGN MOUNTS ON EXISTING STRUCTURE	CUSTOM VARIABLE SUPPOR	C 4X5.4 C 4X7.25	LENGTH	(BASED ON ESTIMATED LENG TH)	MUST BE FIELD VERIFIED)									SIGN DETAILS	ST PEDESTRIAN TION IMPROVEMENTS
108 108 108 108 108 108 108 108 108 108		1 3 3 3 3 3 1 3 1 3 7 3 2 3 1 3 1 3 5 3	36" 36" 36" 36" 36" 36" 36" 36" 36" 36"	36" 36" 36" 36" 36" 36" 36" 36" 36" 36"		X X X X X X X X X X X X X	R R R R R R R R R R G		S S S S S S S S S S			X X X X X X X X X X X X X		108 108		X X X X X X X X X X X X X X X X X X X																2 1/2" - 10 ga. 2 1/2" - 10 ga.	14.0 14.0 14.0 14.0 14.0 14.0 14.0 14.0	43 44 40 42 42 45 44 43 43 43	7.8 Lt 3.8 Lt 4.3 Lt 0.6 Lt 2.9 Lt 9.3 Rt 1.7 Lt 3.1 Rt 7.3 Lt 5.9 Rt	3' - 3 1/2 3' - 3 1/2	1 1 1 1 1 1		Above Sig			S	S IVY S
109 109 109 109 109 109 109 109 109 109 109 109 110 111 112 113 114 115 116 117 118 119 120	121+73.1 125+45.8 127+49.8	B 3 B 1 7 2 1 3 5 1 8 3 1 1 7 7 2 2 3 3	30" 30" 30" 30" 30" 30" 30" 30"	12" 12" 12" 12" 12" 12" 12" 12" 12" 12"		x x x x x x x x x x x x x x x x x x x				W W BK	x x x x x x x x x x x x x x x x x x x		109 109 109 109 109 109 109 109 109 109 109 109 110 111 112 113 114 115 116 117 118 119 120		X																2" - 12 ga.	12.3		3.8 Rt	3 - 3 1/2			Above Sig Above Sig	In 108 In		CLACKAMAS COUNTY	DEPT. OF TRANSPORTATION AND DEVELOPMENT 150 BEAVERCREEK ROAD OREGON CITY, OR 97045
120 120 120 121 121 122 122 EX30	118+83.1 128+58.6 131+80.1 144+42.3 118+19.4 108+06.1 108+06.1 106+84.3	1 3 1 3 4 8 1 8 1 8 8 8 8 8 8 8 8 8 8 8 8 8	30" 30" 30" 24" 24" 24" EX EX LUE ROWN	36" 36" 36" 48" 30" 50" EX			SV SV SV SV SV SV SV		L =	= LEFT I	BK BK BK BK BK C, R AR POST POST			120 120 120 120 121 122 122	~~~	X X X X X X X X X X							 _4/ I			CATION S, OBJ			S AND N			2" - 12 ga. 2" - 12 ga. 2" - 12 ga. 2" - 12 ga. 2" - 12 ga. 2 1/2" - 12 ga. 2" - 12 ga. 3. EXACT LOCATIONS /	12.3 12.3 12.3 12.3 13.8 12.3 13.8 12.3 13.8 12.3 10.3'+	28 29 29 28 28 28 28 28 28 28 28 28 28 28 28 28	3.6 Rt 9.5 Rt 9.5 Lt 4.9 Lt 8.1 Lt 9.4 Lt 9.4 Lt 3.2 Lt	3' - 3 1/2 3' - 3 1/2			Reinstall E	5	} /		CLACKAMAS COUNTY
	s	FY= FL G= GF O= OF R= RE RB= RE SW= SIL W= WH Y= YE	REEN RANGE ED ED-BLU LVER-V 'HITE	ie White		.ow			3/ DI TC		FROM	INE OF	FOOTI	NG. FOR	ANE, FAC Additi								- 1	BREAKA	WAYI	NSTAL	ATION	IS IS FO	OR A 2'	DIAMET		AWAY AND MULTI-POS 5. FOR ADDITIONAL	ST									DESIGNED	C. COX
																																							REG	ERED PROFZ ENGINEE 60404PE	F	REVISIONS	Phase 2 sidewalk and pavement grind and inlay
																																	4	951 SW PORTL	/ 6TH _AND,	AVENU OR 972	ELSON CIATES 6, SUITE 600 04 503.273.816	N S 0	(TA)	OREGON	R005		TB04 4 4/29/2025 4 4/29/2025




Plot Stamp: 5/26/2025 12:49:21 PM - Dimitryan Shadrin File: H:\23\23982 - Ivy Street Pedestrian Improvements

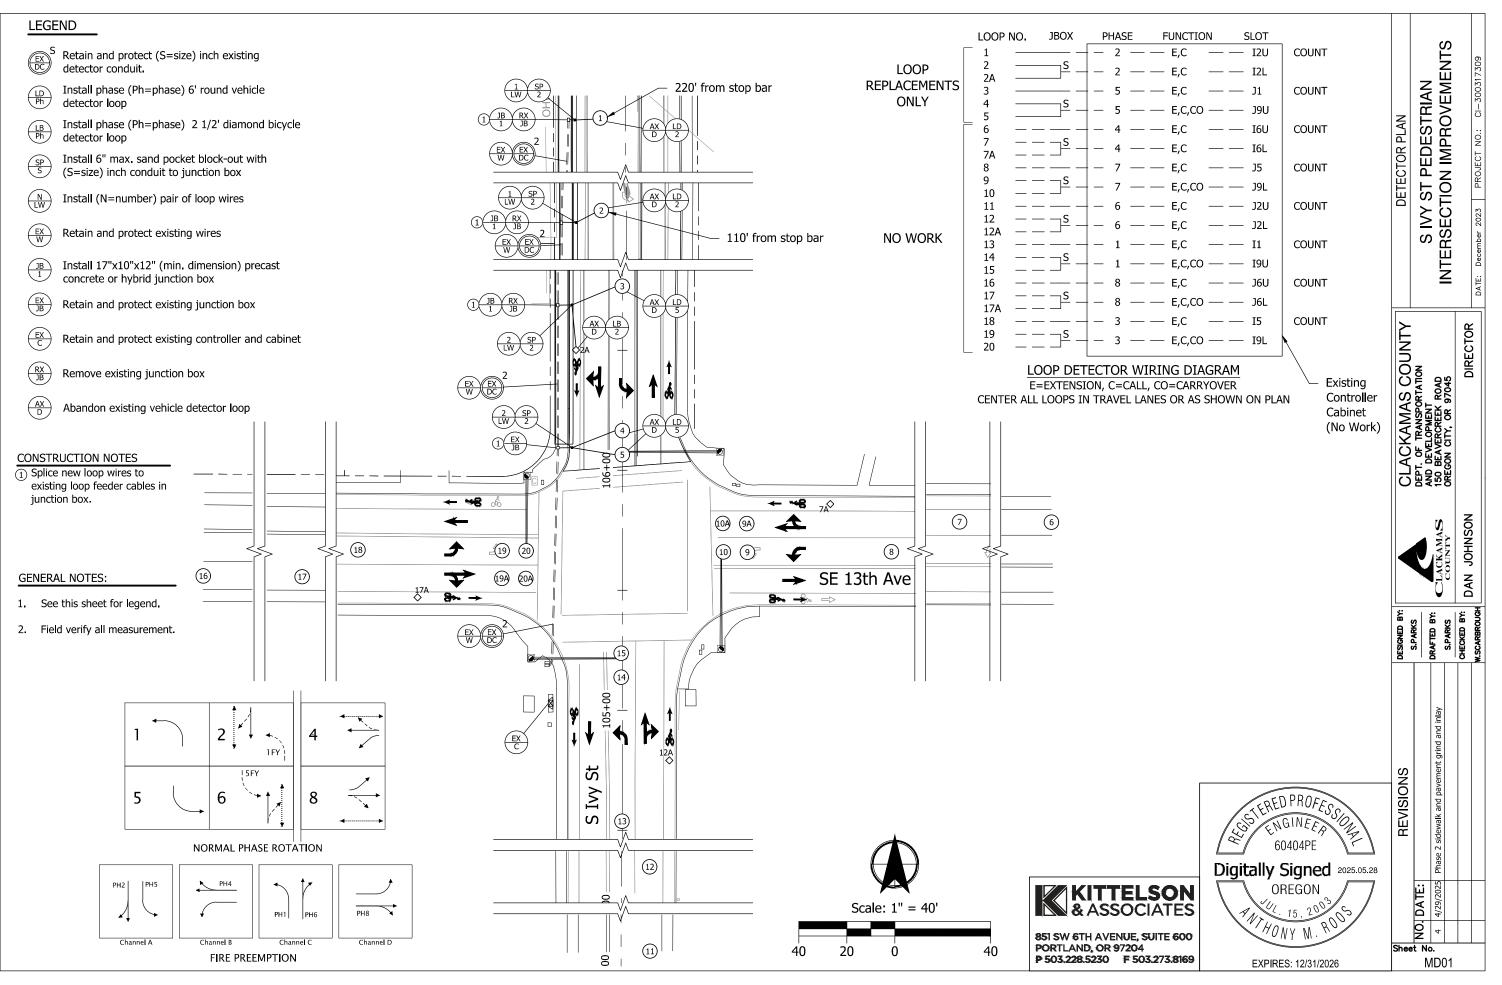



Plot Stamp: 5/28/2025 10:15:26 AM - Dimitryan Shadrin File: H:\23\23982 - Ivy Street Pedestrian Improvements\design_CD\MA-SIGNAL PLA

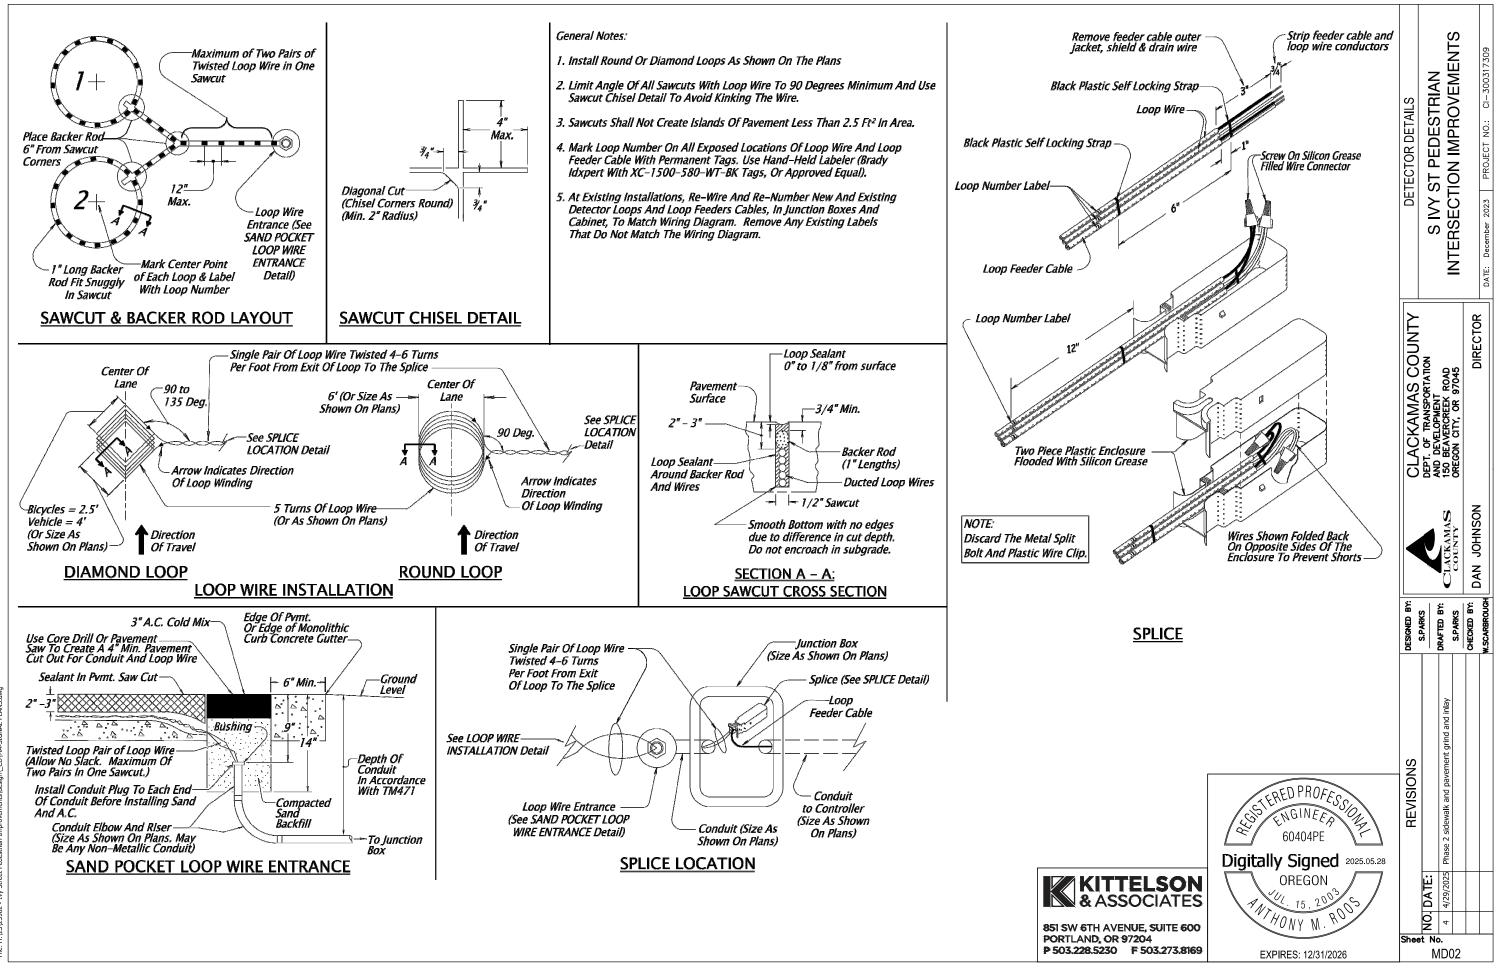


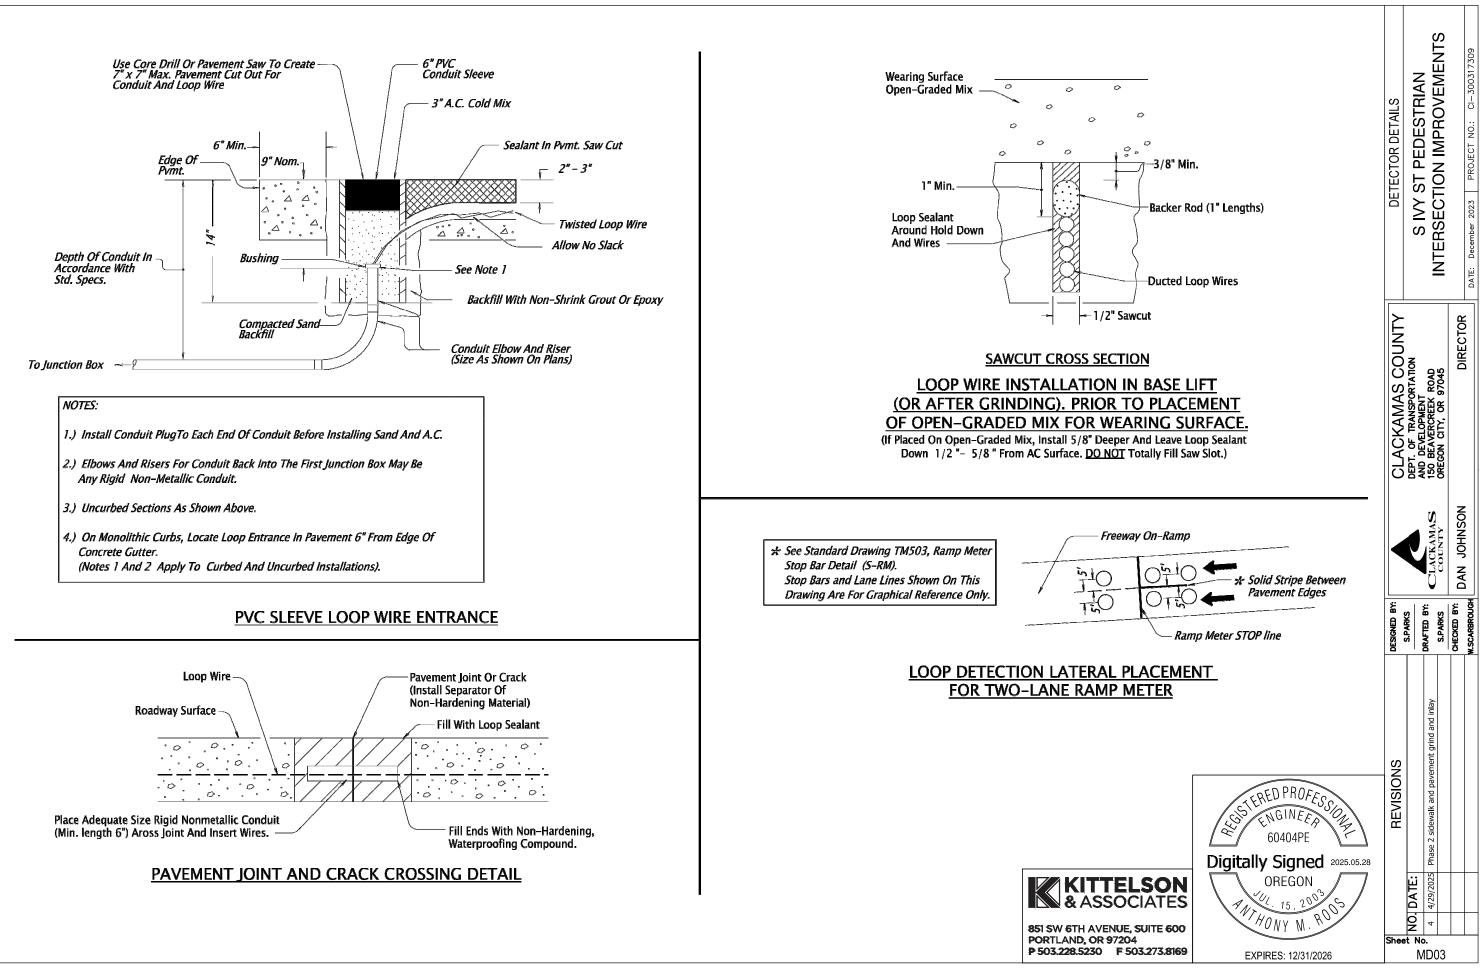



:22 AM -10:17: 025 Ivy Plot File:

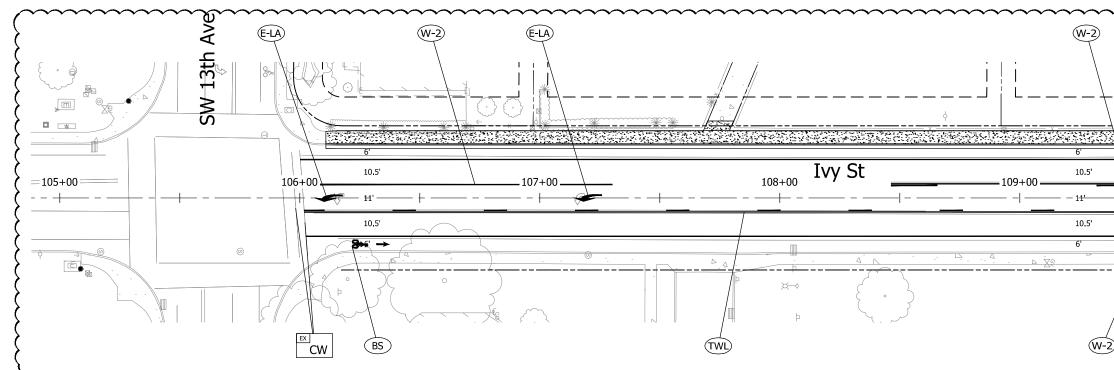

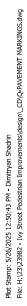

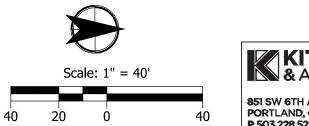

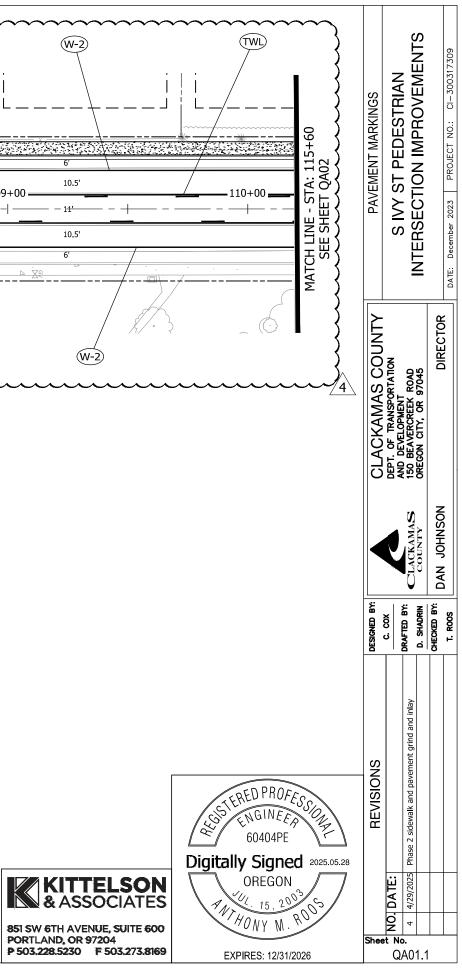

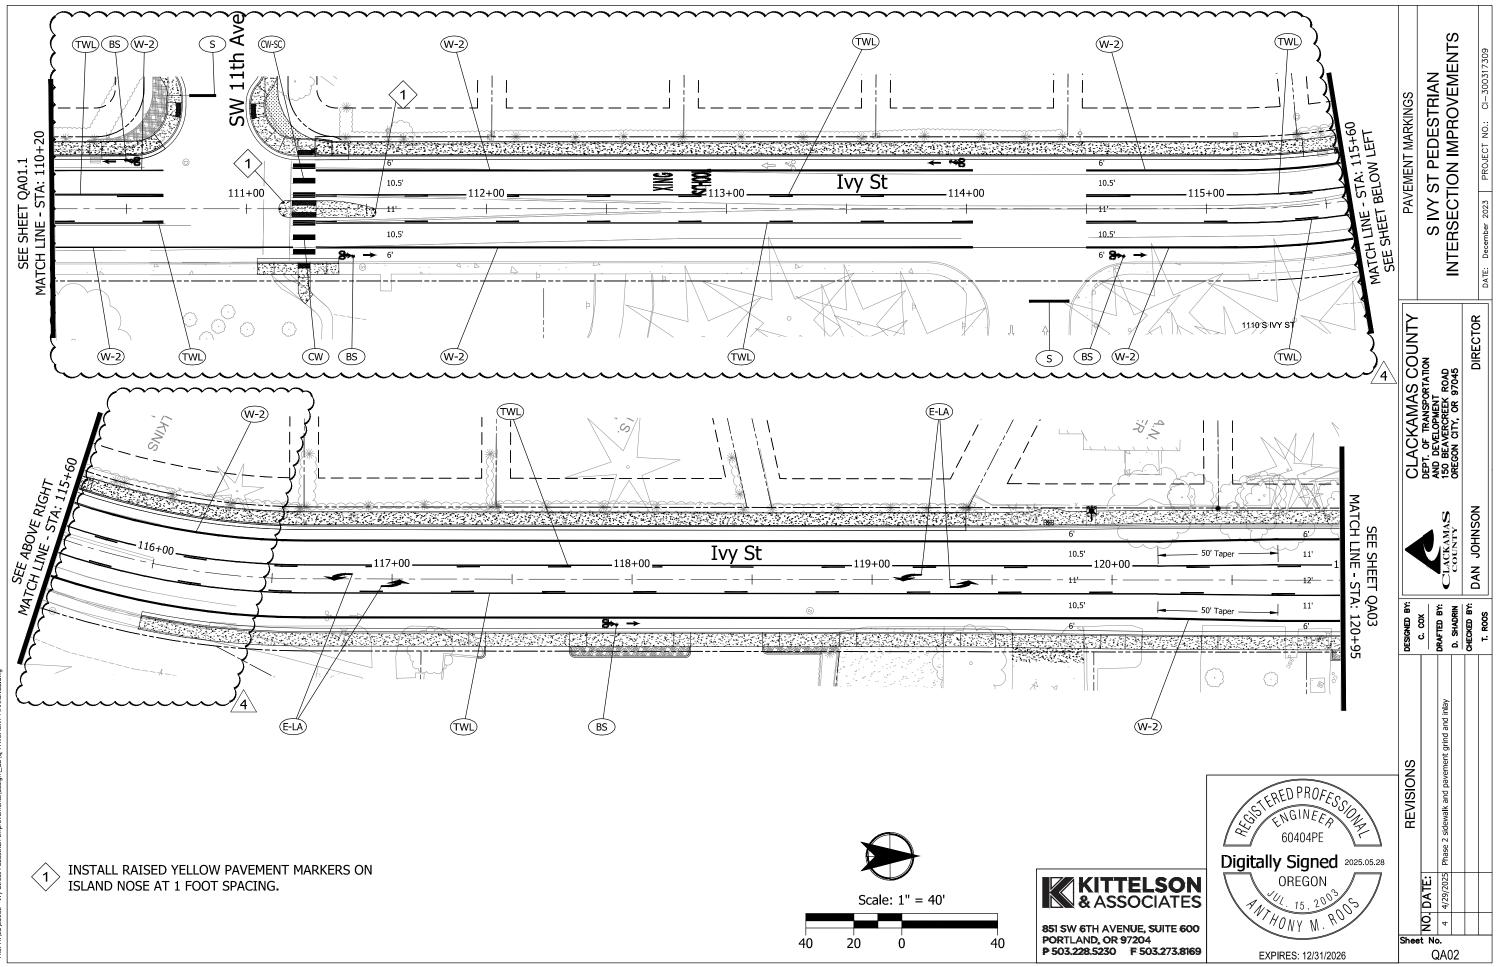

12:58 Plot File: